NEW BUILDING WORKS

Residential House

17 ANEMBO AVE, GEORGES HALL, NSW 2198

DEVELOPMENT APPLICATION

DRAWING LIST:

NOTIFICATION PLAN PROJECT SUMMARY MATERIAL SHCEDULE SITE PLAN& SITE ANALYSIS PROPOSED DEMOLITION PLAN PROPOSED GARAGE PLAN PROPOSED GROUND FLOOR PLAN PROPOSED FIRST FLOOR PLAN PROPOSED ROOF PLAN PROPOSED DIMENSION GARAGE PROPOSED DIMENSION GROUND FLOOR PROPOSED DIMENSION FIRST FLOOR DA402 **ELEVATIONS** DA500

ELEVATIONS DA501 **ELEVATIONS** SECTIONS SHADOW DIAGRAM **FSR DIAGRAM** GLAZING SCHEDULE





FOR DA SUBMISSION

17 ANEMBO AVE, GEORGES HALL, NSW 2198

AS INDICATED

GENERAL NOTES:

1. DO NOT SCALE OFF DRAWINGS. USE ONLY FIGURED DIMENSIONS.

COMMENCEMENT OF ANY WORK.

SMALLER WHICH ARE IN METRES.

- 2. ALL DIMENSIONS ARE TO BE VERIFIED ON SITE PRIOR TO
- 3. ANY DISCREPANCIES ARE TO BE BROUGHT TO THE ATTENTION OF OIC DESIGN PTY LTD BEFORE COMMENCEMENT OF ANY WORK.
- 4. ALL DIMENSIONS ARE GIVEN IN MILLIMETRES EXCEPT LEVELS & DRAWINGS TO SCALE 1:500 AND
- 5. THIS DRAWING IS TO BE READ IN CONJUNCTION WITH RELEVANT CONSULTANTS DOCUMENTATION.
- 6. ALL DESIGNS, PRINTS & SPECIFICATIONS ARE THE PROPERTY OF OIC DESIGN PTY LTD & MUST NOT BE ISSUED, USED OR REPRODUCED

CONSTRUCTION NOTES:

- 1. DRAWINGS ARE TO BE READ IN CONJUNCTION WITH THE DESIGN SPECIFICATIONS & SCHEDULES.
- 2. REFER TO ENGINEER'S DRAWINGS & SPECIFICATIONS FOR ALL STRUCTURAL, HYDRAULIC, MECHANICAL, ELECTRICAL & KITCHEN REQUIREMENTS & DETAILS. ENGINEER'S DRAWINGS ARE TO TAKE PRECEDENCE OVER ANY STRUCTURAL, HYDRAULIC, MECHANICAL & ELECTRICAL INFORMATION ON THE CONSTRUCTION DRAWINGS, SCHEDULES & SPECIFICATIONS. SUCH
 DISCREPANCIES ARE TO BE BROUGHT TO THE ATTENTION OF OIC DESIGN.
- 3. ALL BUILDING WORK IS TO BE CARRIED OUT IN ACCORDANCE WITH THE PROVISIONS OF THE BUILDING CODE OF AUSTRALIA (BCA) & THE RELEVANT AUSTRALIAN STANDARDS.
- 4. EXISTING CONDITIONS SHOWN ON THESE DRAWINGS HAVE BEEN PROVIDED BY THE CLIENT. CHECK ON SITE PRIOR TO PROCEEDING WITH ANY WORKS BASED ON THIS INFORMATION.
- 5. CONTRACTORS TO ENSURE ADEQUATE STRENGTH & STABILITY OF ALL ITEMS.
- 6. ALL ARCHITECTURAL STEEL/TIMBER SIZING & THICKNESS SHOWN ON DRAWINGS SHOW DESIGN INTENT ONLY & STEEL FABRICATORS AND/OR HEAD CONTRACTORS ARE TO SIZE STEEL/TIMBER MEMBERS TO ENSURE STRUCTURAL ADEQUACY, RIGIDITY & STRENGTH OF ALL COMPONENTS TO SUIT SPECIFIC APPLICATIONS.

A 21.07.2022 FOR DA SUBMISSION

CHERYL NGUYEN

OIC DESIGN PTY LTD. (ABN 89 645 958 247)


A1/ 35-39 BURKE ROAD ALEXANDRIA NSW 2015 Ph. 04 5066 1226


17 ANEMBO AVE, GEORGES HALL, NSW 2198

COVER SHEET


JOB NUMBER

S:\WORKING FOLDER\2101_ HOUSE DESIGN_17 Anembo Ave, Georges Hall, NSW 2198\1_REVIT\17 Anembo Ave, Georges Hall.rvt 7/21/2022 6:54:24 PM

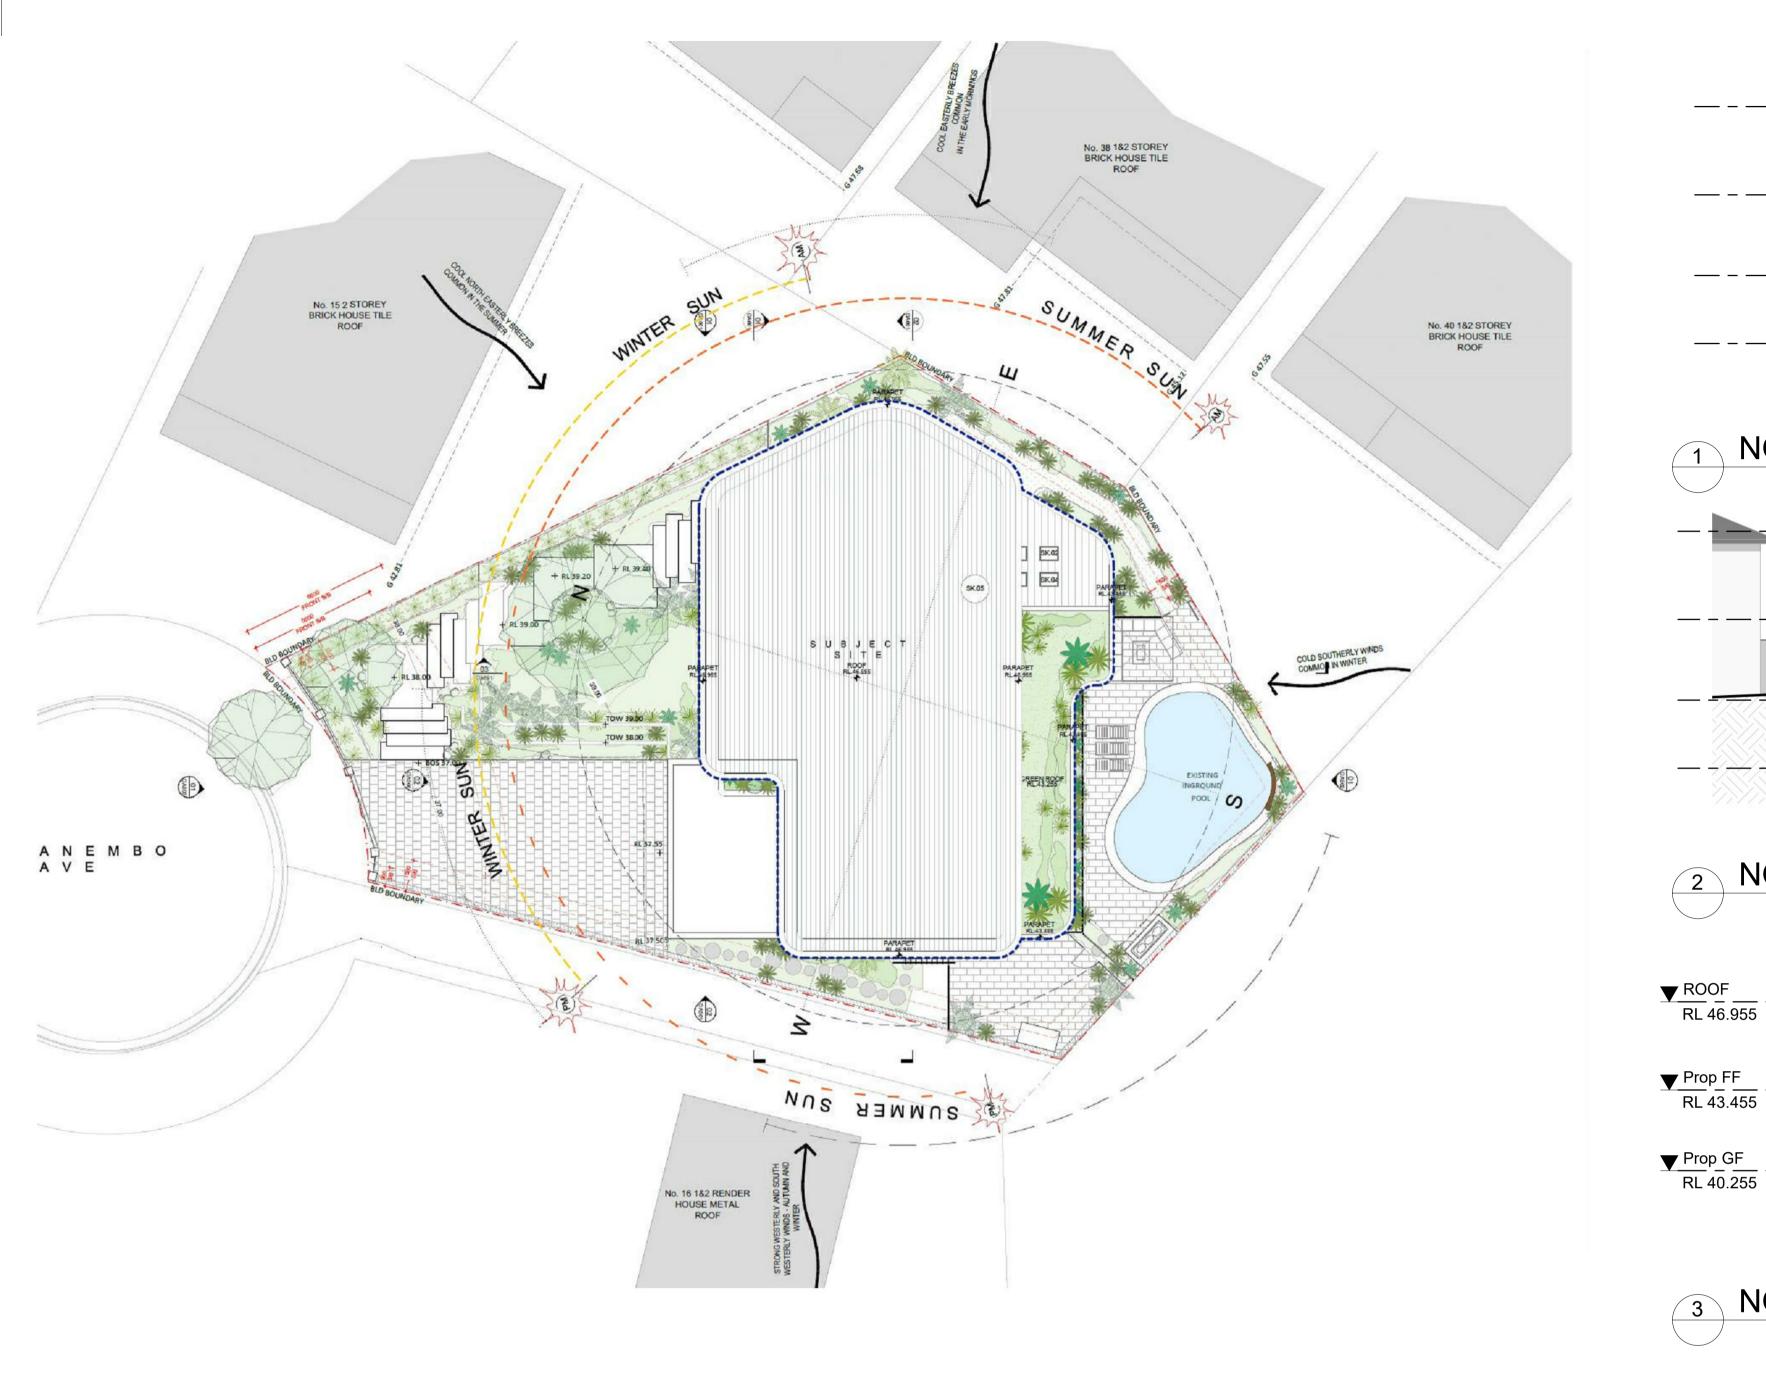

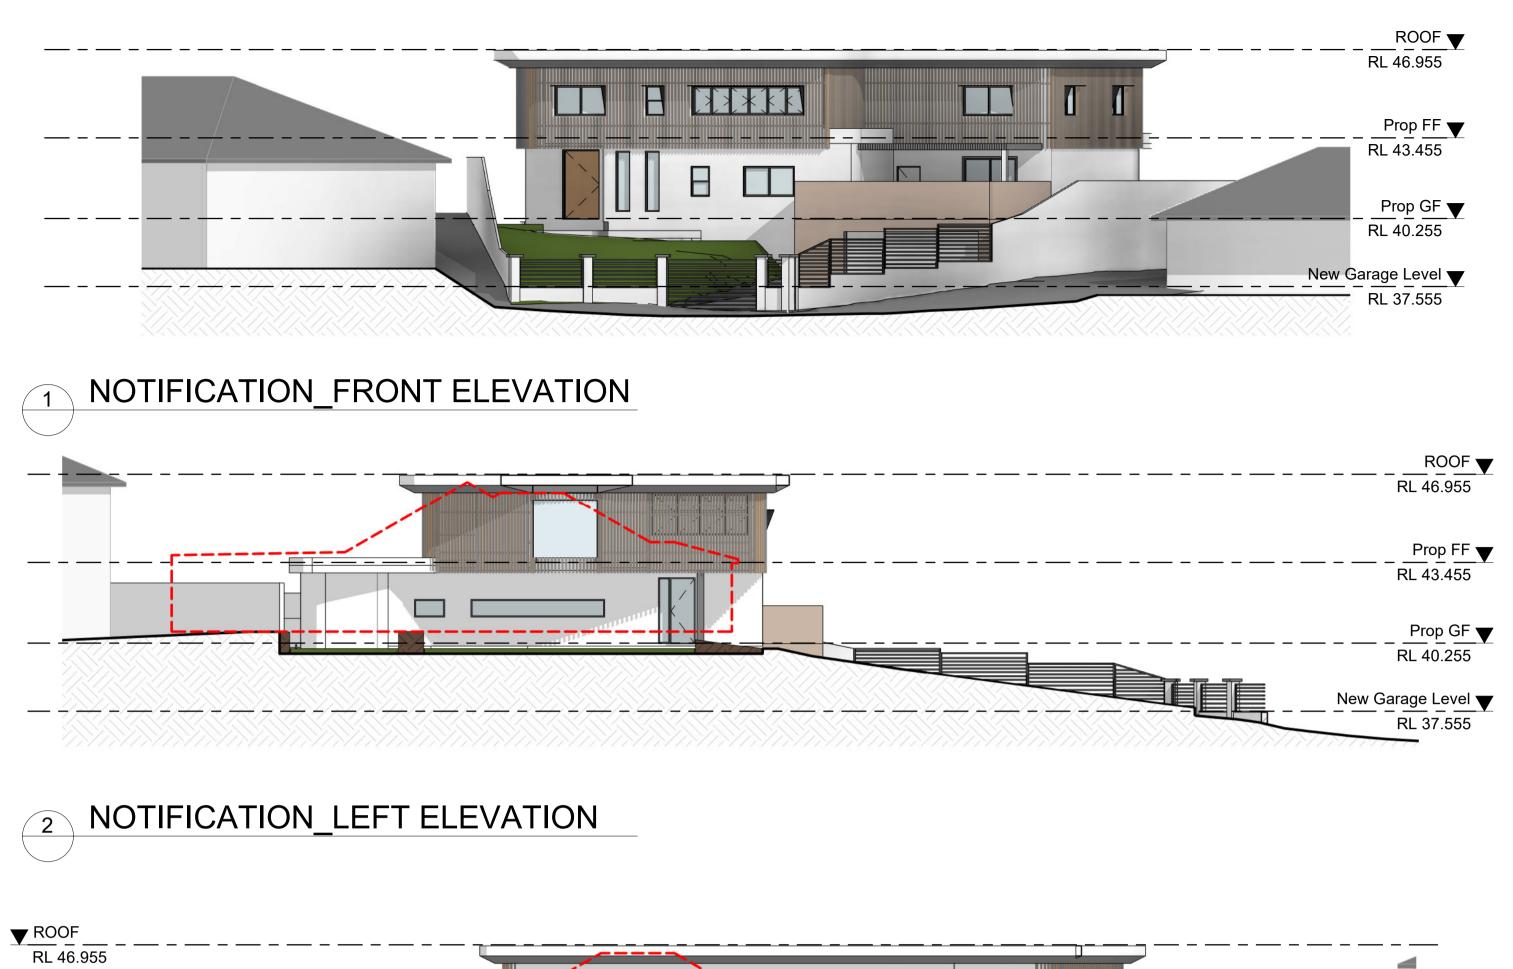

3 NOTIFICATION_REAR ELEVATION

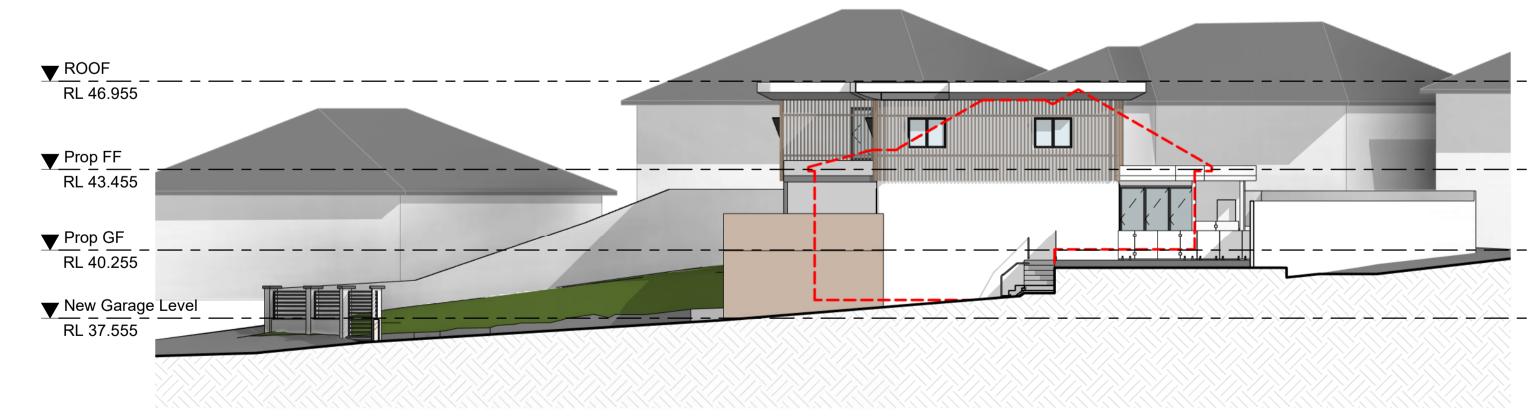

4 NOTIFICATION_RIGHT ELEVATION



This document should not be relied on or used in circumstances other than those for which it was originally prepared and for which OIC DESGIN PTY LTD was commissioned. OIC DESGIN PTY LTD accepts no responsibility for this document to any other party other than the person by whom it was commissioned.

2101

PROJECT

17 ANEMBO AVE, GEORGES HALL, NSW 2198 NOTIFICATION PLAN

DRAWING

1:100@A1 1:200@A3

DA 0000



	PROJECT INFORMATION			
Project Address	17 ANEMBO AVE, GEORGES HALL, N	SW, 2198		
Lot/Section/Plan No	25/-/DP235447			
Council	Canterbury-Bankstown Council			
	Red	quirement	Proposed	Compliance
Site Area (m2)	961.1	sqm		
Zoning	R2	Low Density Residential		
Height Control	9M			
FSR Control	0.5	1		
Allowable GFA	480.5	sqm	480 sqm	✓
Minimum Landscape Area	45% between the dwelling and primary road frontage	131.7sqm	268.0 sqm	✓
Private Open Space	80	sqm	202 sqm	✓
Side Setback	Wall height <7m	0.9m	5.5 m	✓
	Wall height >7m	1.5m	2.4 m	✓
Front Setback	First Storage	5.5m	17.4 m	✓
	Second Storage	6.5m	17.4 m	✓

GFA CALCULATION		
Garage	41.5	sqm
Ground Floor	246.19	sqm
First Floor	202.4	sqm
Total Proposed GFA	448.59	sqm
Allowable GFA	480.5	sqm



FOR DA SUBMISSION

PROJECT ADDRESS

17 ANEMBO AVE
GEORGES HALLS
NSW

NORTH

GENERAL NOTES:

DO NOT SCALE OFF DRAWINGS.
 USE ONLY FIGURED DIMENSIONS.

- ALL DIMENSIONS ARE TO BE VERIFIED ON SITE PRIOR TO COMMENCEMENT OF ANY WORK.
- 3. ANY DISCREPANCIES ARE TO BE BROUGHT TO THE ATTENTION OF OIC DESIGN PTY LTD
- BEFORE COMMENCEMENT OF ANY WORK.
- 4. ALL DIMENSIONS ARE GIVEN IN MILLIMETRES EXCEPT LEVELS & DRAWINGS TO SCALE 1:500 AND SMALLER WHICH ARE IN METRES.
- 5. THIS DRAWING IS TO BE READ IN CONJUNCTION WITH RELEVANT CONSULTANTS DOCUMENTATION.
- 6. ALL DESIGNS, PRINTS & SPECIFICATIONS ARE THE PROPERTY OF OIC DESIGN PTY LTD & MUST NOT BE ISSUED, USED OR REPRODUCED WITHOUT WRITTEN PREMISSION FROM

DA NOTES:

OIC DESIGN PTY LTD.

- DRAWINGS ARE TO BE READ IN CONJUNCTION WITH THE DEVELOPMENT APPLICATION FORM AND STATEMENT OF ENVIRONMENTAL EFFECTS.
- THE NEW BUILDING WORK IS TO BE CARRIED OUT IN ACCORDANCE WITH THE PROVISIONS OF THE BCA.
- 3. ALL NEW BUILDING WORK IS TO BE CARRIED OUT IN ACCORDANCE WITH THE NOTICE OF DETERMINATION FOR THIS DEVELOPMENT APPLICATION.
- 4. DISABILITY ACCESS AND FACILITIES TO BE IN ACCORDANCE WITH AS 1428.1 AND AS 1428.4
- 5. THE PROPOSED WORKS WILL ADDRESS FIRE SAFETY MEASURES TO COMPLY WITH THE PERFORMANCE REQUIREMENTS OF THE BCA (EITHER DEEMED TO SATISFY OR ALTERNATIVE SOLUTIONS TO BE PREPARED BY A QUALIFIED FIRE ENGINEER).
- 6. ALL MEANS OF EGRESS, EMERGENCY LIGHTING, EXIT SIGNS, FIRE DOORS, FIRE HYDRANT SYSTEMS, FIRE HOSE REEL SYSTEMS, PORTABLE FIRE EXTINGUISHERS, SMOKE AND HEAT VENTS, SMOKE DETECTION, ALARM AND EXHAUST SYSTEM TO BE IN ACCORDANCE WITH THE BCA AND OTHER RELEVANT AUSTRALIAN STANDARDS.

A 21.07.2022 FOR DA SUBMISSION

REV DATE DESCRIPTION

CLIENT

CHERYL NGUYEN

ARCHITECT

OIC DESIGN PTY LTD. (ABN 89 645 958 247) A1/ 35-39 BURKE ROAD ALEXANDRIA NSW 2015 Ph. 04 5066 1226


PROJECT

17 ANEMBO AVE RESIDENCE

DRAWING

PROJECT SUMMARY

SCALE NTS @A1	DA010	REVISION
JOB NUMBER	DRAWN BY	DATE
2101	CC	JUL 22

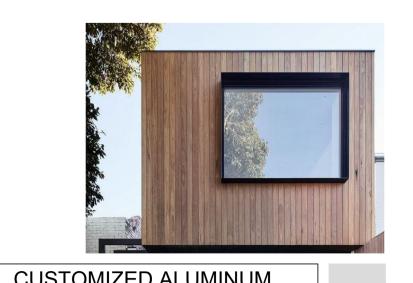



Colour (P1) Dulux - MONUMENT C29 (OR SIMILAR)



Colour : OKU _ TIMBER FINISHED





ALUMINUM LOOK PERGOLA

Colour to match with Aluminum Batten Screen

RENDERED AWNING

Colour (P3) Dulux - Natural White (OR SIMILAR)

CUSTOMIZED ALUMINUM **FRAME**

Colour (P1) Dulux - MONUMENT C29 (OR SIMILAR)



CUSTOMIZED TIMBER DOOR

PIVOT ENTRANCE DOOR

TEXTURE RENDERED WALL

Colour (P2) Dulux - Whisper White (OR SIMILAR) Medium Texture





DULUX - MONUMENT (C29) or similar ALUMINUM FRAMED GLAZING / CUSTOMIZED ALUMINUM FRAME / PERGOLA FRAMING

WHISPER WHITE (SW1C2)

NATURAL WHITE (SW1F4)

TEXTURE RENDERED WALL

AWNING

EXPOSE AGGREGATE DRIVEWAY SNOWDRIFT (OR SIMILAR)



SANDSTONE CLADDING

ECO OUTDOOR CRACKENBACK FREE FORMED RANGE OR SIMILAR



ROLLER SHUTTER

COLOR TO MATCH WITH TEXTURE RENDER WALL

FOR DA SUBMISSION

PROJECT ADDRESS 17 ANEMBO AVE **GEORGES HALLS** NSW

NORTH

GENERAL NOTES:

DO NOT SCALE OFF DRAWINGS.
 USE ONLY FIGURED DIMENSIONS.

2. ALL DIMENSIONS ARE TO BE VERIFIED ON SITE PRIOR TO COMMENCEMENT OF ANY WORK.

3. ANY DISCREPANCIES ARE TO BE BROUGHT TO THE ATTENTION OF OIC DESIGN PTY LTD BEFORE COMMENCEMENT OF ANY WORK.

4. ALL DIMENSIONS ARE GIVEN IN MILLIMETRES EXCEPT LEVELS & DRAWINGS TO SCALE 1:500 AND SMALLER WHICH ARE IN METRES.

5. THIS DRAWING IS TO BE READ IN CONJUNCTION

WITH RELEVANT CONSULTANTS DOCUMENTATION. 6. ALL DESIGNS, PRINTS & SPECIFICATIONS ARE THE

PROPERTY OF OIC DESIGN PTY LTD &

MUST NOT BE ISSUED, USED OR REPRODUCED WITHOUT WRITTEN PREMISSION FROM OIC DESIGN PTY LTD.

DA NOTES:

1. DRAWINGS ARE TO BE READ IN CONJUNCTION WITH THE DEVELOPMENT APPLICATION FORM AND STATEMENT OF ENVIRONMENTAL EFFECTS.

2. THE NEW BUILDING WORK IS TO BE CARRIED OUT IN ACCORDANCE WITH THE PROVISIONS OF THE BCA.

3. ALL NEW BUILDING WORK IS TO BE CARRIED OUT IN ACCORDANCE WITH THE NOTICE OF DETERMINATION FOR THIS DEVELOPMENT APPLICATION.

4. DISABILITY ACCESS AND FACILITIES TO BE IN ACCORDANCE WITH AS 1428.1 AND AS 1428.4

5. THE PROPOSED WORKS WILL ADDRESS FIRE SAFETY MEASURES TO COMPLY WITH THE PERFORMANCE REQUIREMENTS OF THE BCA (EITHER DEEMED TO SATISFY OR ALTERNATIVE SOLUTIONS TO BE PREPARED BY A QUALIFIED FIRE ENGINEER).

6. ALL MEANS OF EGRESS, EMERGENCY LIGHTING, EXIT SIGNS, FIRE DOORS, FIRE HYDRANT SYSTEMS, FIRE HOSE REEL SYSTEMS, PORTABLE FIRE EXTINGUISHERS, SMOKE AND HEAT VENTS, SMOKE DETECTION, ALARM AND EXHAUST SYSTEM TO BE IN ACCORDANCE WITH THE BCA AND OTHER RELEVANT AUSTRALIAN STANDARDS.

A 21.07.2022 FOR DA SUBMISSION

DESCRIPTION CLIENT

CHERYL NGUYEN

ARCHITECT

OIC DESIGN PTY LTD. (ABN 89 645 958 247) A1/ 35-39 BURKE ROAD ALEXANDRIA NSW 2015 Ph. 04 5066 1226

PROJECT


17 ANEMBO AVE RESIDENCE

MATERIAL SCHEDULE

SCALE DRAWING NO. REVISION **DA100** JOB NUMBER DRAWN BY 2101



PROJECT ADDRESS 17 ANEMBO AVE GEORGES HALLS NSW

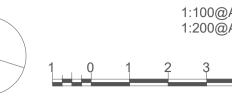

GENERAL NOTES:

- DO NOT SCALE OFF DRAWINGS.
 USE ONLY FIGURED DIMENSIONS.
- 2. ALL DIMENSIONS ARE TO BE VERIFIED ON SITE PRIOR TO COMMENCEMENT OF ANY WORK.
- 3. ANY DISCREPANCIES ARE TO BE BROUGHT TO THE ATTENTION OF OIC DESIGN PTY LTD BEFORE COMMENCEMENT OF ANY WORK.
- 4. ALL DIMENSIONS ARE GIVEN IN MILLIMETRES EXCEPT LEVELS & DRAWINGS TO SCALE 1:500 AND SMALLER WHICH ARE IN METRES.
- 5. THIS DRAWING IS TO BE READ IN CONJUNCTION WITH RELEVANT CONSULTANTS DOCUMENTATION.
- 6. ALL DESIGNS, PRINTS & SPECIFICATIONS ARE THE PROPERTY OF OIC DESIGN PTY LTD & MUST NOT BE ISSUED, USED OR REPRODUCED
- WITHOUT WRITTEN PREMISSION FROM OIC DESIGN PTY LTD.

- DRAWINGS ARE TO BE READ IN CONJUNCTION WITH THE DEVELOPMENT APPLICATION FORM AND STATEMENT OF ENVIRONMENTAL EFFECTS.
- 2. THE NEW BUILDING WORK IS TO BE CARRIED OUT IN ACCORDANCE WITH THE PROVISIONS OF THE BCA.
- 3. ALL NEW BUILDING WORK IS TO BE CARRIED OUT IN ACCORDANCE WITH THE NOTICE OF DETERMINATION FOR THIS DEVELOPMENT APPLICATION.
- 4. DISABILITY ACCESS AND FACILITIES TO BE IN ACCORDANCE WITH AS 1428.1 AND AS 1428.4
- 5. THE PROPOSED WORKS WILL ADDRESS FIRE SAFETY MEASURES TO COMPLY WITH THE PERFORMANCE REQUIREMENTS OF THE BCA (EITHER DEEMED TO SATISFY OR ALTERNATIVE SOLUTIONS TO BE PREPARED BY A QUALIFIED FIRE ENGINEER).
- 6. ALL MEANS OF EGRESS, EMERGENCY LIGHTING, EXIT SIGNS, FIRE DOORS, FIRE HYDRANT SYSTEMS, FIRE HOSE REEL SYSTEMS, PORTABLE FIRE EXTINGUISHERS, SMOKE AND HEAT VENTS, SMOKE DETECTION, ALARM AND EXHAUST SYSTEM TO BE IN ACCORDANCE WITH THE BCA AND OTHER RELEVANT AUSTRALIAN STANDARDS.

A 21.07.2022 FOR DA SUBMISSION

REV DATE DESCRIPTION

CHERYL NGUYEN

ARCHITECT OIC


OIC DESIGN PTY LTD. (ABN 89 645 958 247) A1/ 35-39 BURKE ROAD ALEXANDRIA NSW 2015

Ph. 04 5066 1226 PROJECT

17 ANEMBO AVE RESIDENCE

SITE PLAN & SITE ANALYSIS

SCALE 1:100 @A1	DRAWING NO.	REVISION
JOB NUMBER	DRAWN BY	DATE
2101	CC	JUL 22

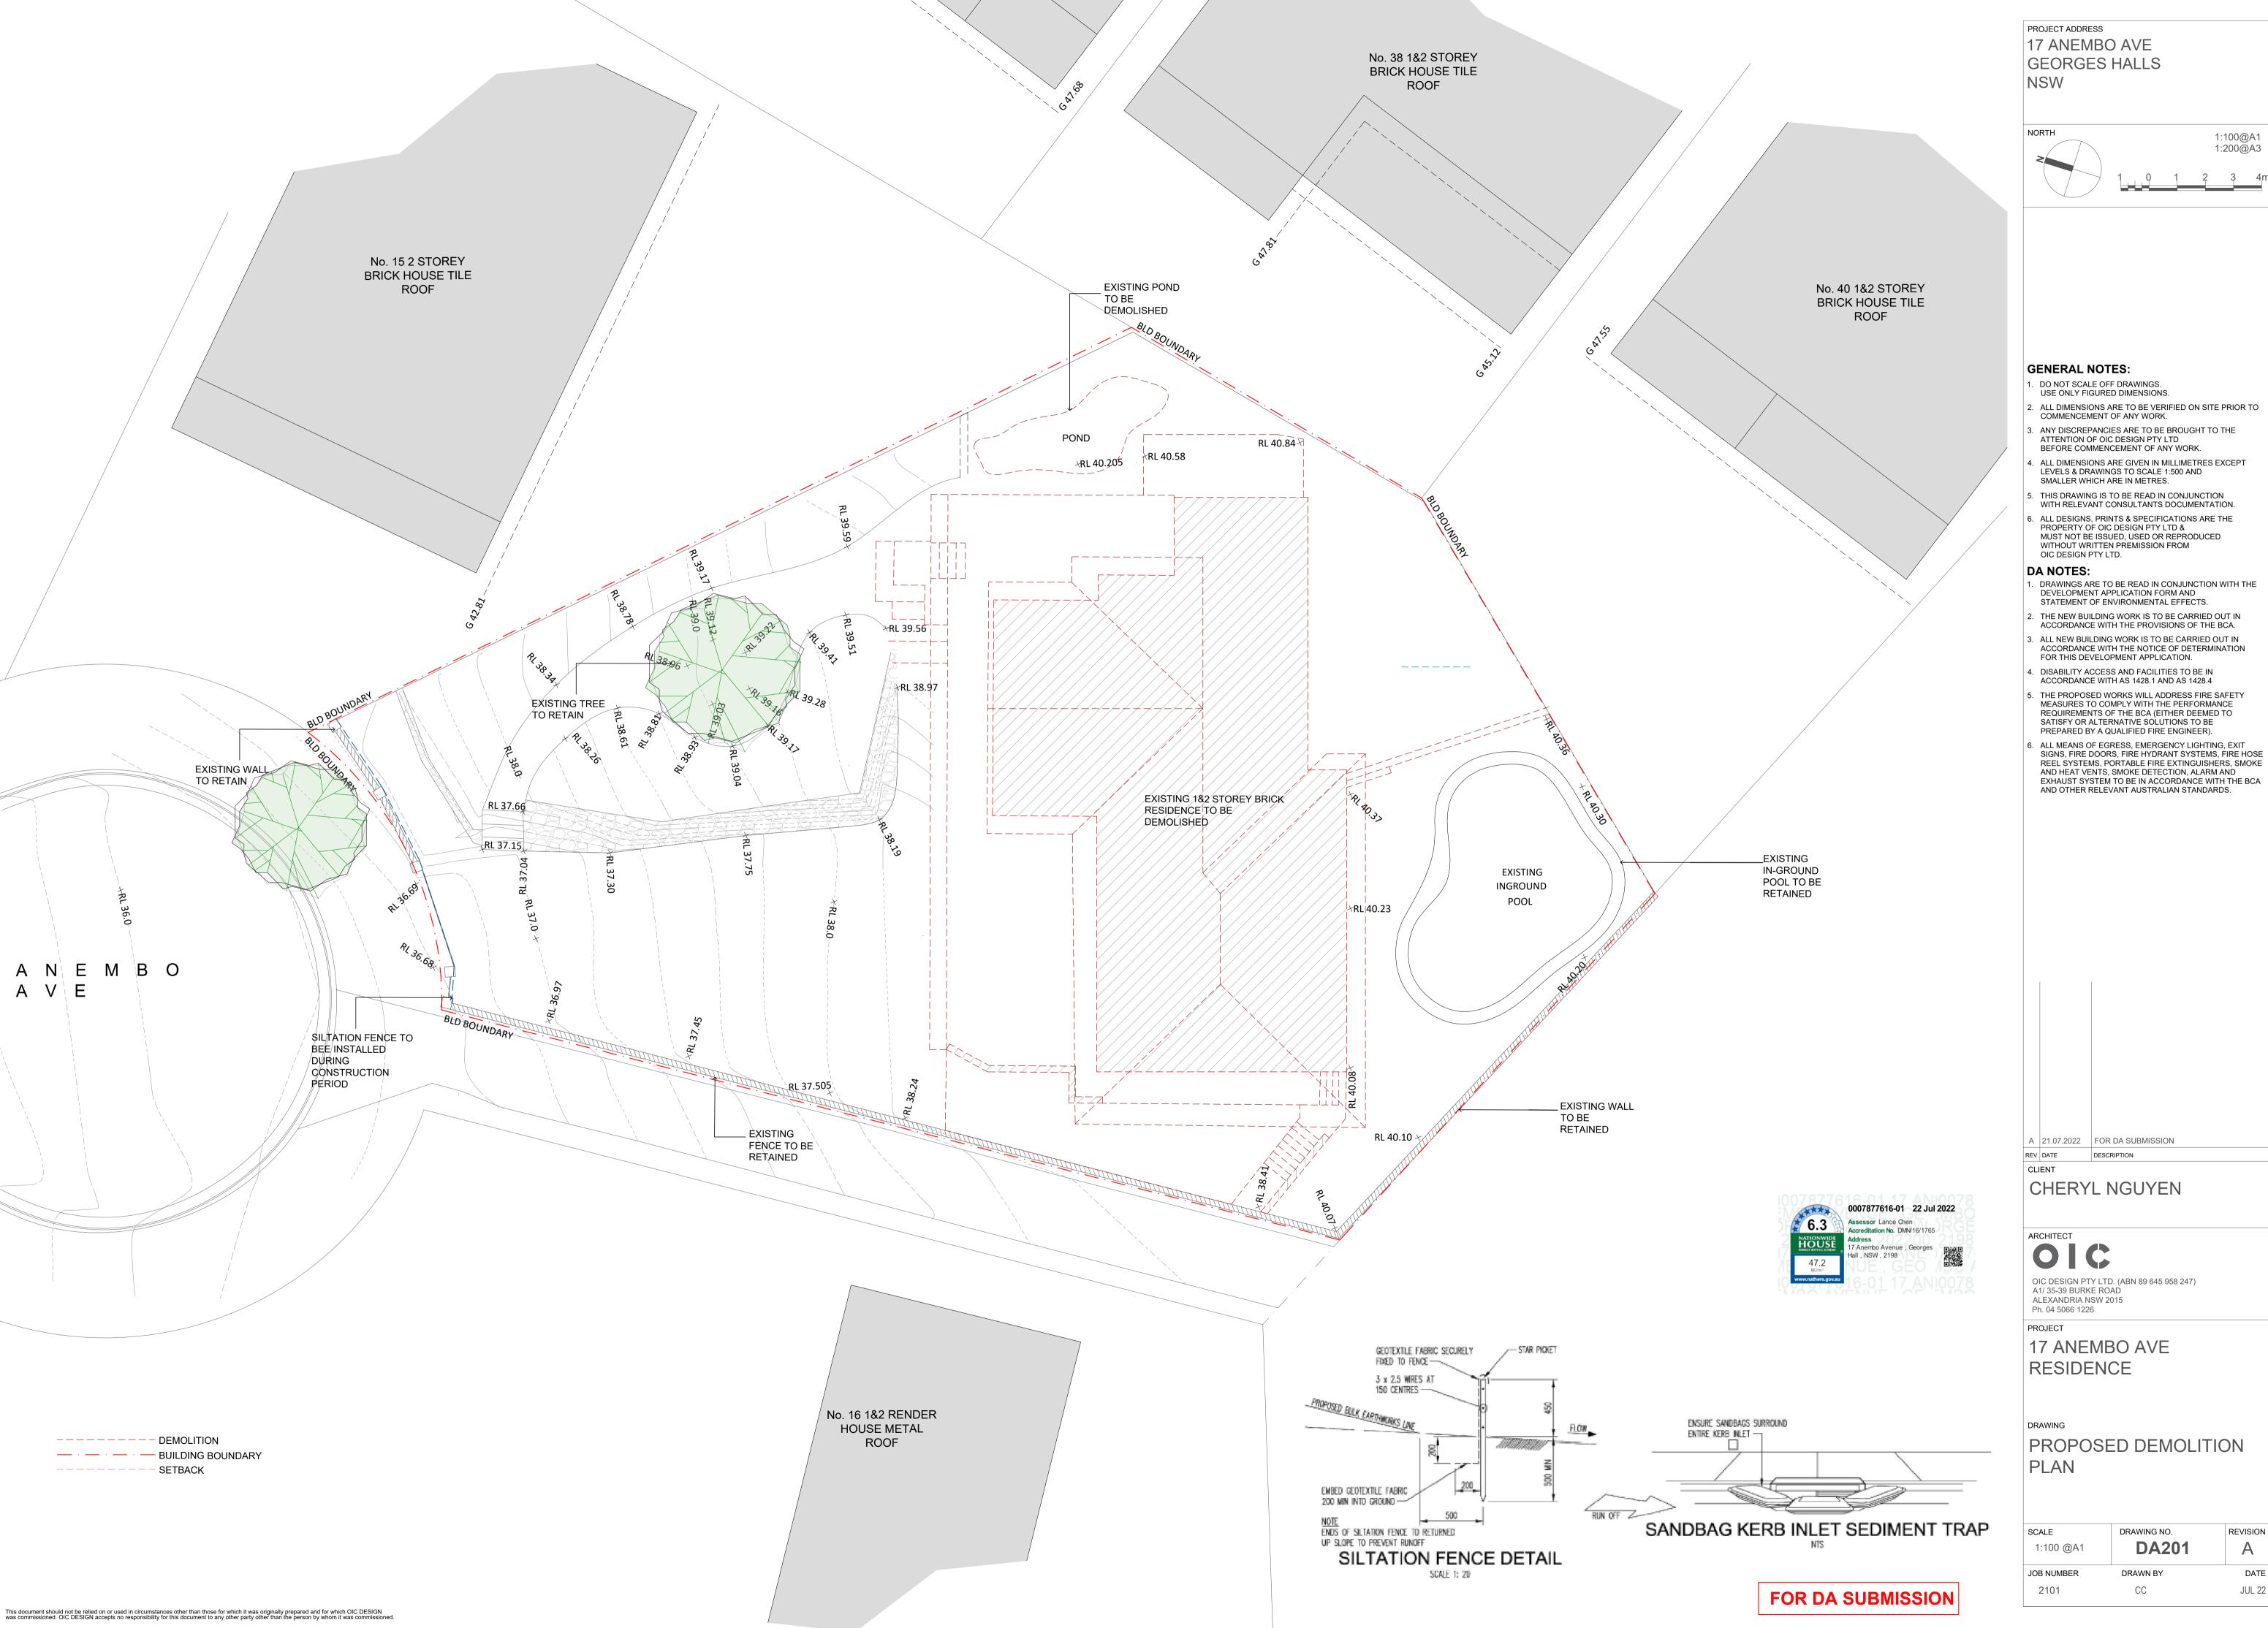

- ACCORDANCE WITH THE PROVISIONS OF THE BCA.
- ACCORDANCE WITH THE NOTICE OF DETERMINATION
- ACCORDANCE WITH AS 1428.1 AND AS 1428.4
- MEASURES TO COMPLY WITH THE PERFORMANCE REQUIREMENTS OF THE BCA (EITHER DEEMED TO SATISFY OR ALTERNATIVE SOLUTIONS TO BE
- REEL SYSTEMS, PORTABLE FIRE EXTINGUISHERS, SMOKE AND HEAT VENTS, SMOKE DETECTION, ALARM AND EXHAUST SYSTEM TO BE IN ACCORDANCE WITH THE BCA AND OTHER RELEVANT AUSTRALIAN STANDARDS.

PROPOSED DEMOLITION

CALE 1:100 @A1	DRAWING NO.	REVISION
B NUMBER	DRAWN BY	DATE
2101	CC	JUL 22



PROJECT ADDRESS 17 ANEMBO AVE **GEORGES HALLS** NSW





GENERAL NOTES:

- DO NOT SCALE OFF DRAWINGS.
 USE ONLY FIGURED DIMENSIONS.
- 2. ALL DIMENSIONS ARE TO BE VERIFIED ON SITE PRIOR TO COMMENCEMENT OF ANY WORK.
- 3. ANY DISCREPANCIES ARE TO BE BROUGHT TO THE ATTENTION OF OIC DESIGN PTY LTD BEFORE COMMENCEMENT OF ANY WORK.
- 4. ALL DIMENSIONS ARE GIVEN IN MILLIMETRES EXCEPT LEVELS & DRAWINGS TO SCALE 1:500 AND SMALLER WHICH ARE IN METRES.
- 5. THIS DRAWING IS TO BE READ IN CONJUNCTION WITH RELEVANT CONSULTANTS DOCUMENTATION.
- 6. ALL DESIGNS, PRINTS & SPECIFICATIONS ARE THE
- PROPERTY OF OIC DESIGN PTY LTD &
 MUST NOT BE ISSUED, USED OR REPRODUCED WITHOUT WRITTEN PREMISSION FROM OIC DESIGN PTY LTD.

- DRAWINGS ARE TO BE READ IN CONJUNCTION WITH THE DEVELOPMENT APPLICATION FORM AND STATEMENT OF ENVIRONMENTAL EFFECTS.
- 2. THE NEW BUILDING WORK IS TO BE CARRIED OUT IN ACCORDANCE WITH THE PROVISIONS OF THE BCA.
- 3. ALL NEW BUILDING WORK IS TO BE CARRIED OUT IN ACCORDANCE WITH THE NOTICE OF DETERMINATION
- FOR THIS DEVELOPMENT APPLICATION.
- 4. DISABILITY ACCESS AND FACILITIES TO BE IN ACCORDANCE WITH AS 1428.1 AND AS 1428.4
- 5. THE PROPOSED WORKS WILL ADDRESS FIRE SAFETY
- MEASURES TO COMPLY WITH THE PERFORMANCE REQUIREMENTS OF THE BCA (EITHER DEEMED TO SATISFY OR ALTERNATIVE SOLUTIONS TO BE PREPARED BY A QUALIFIED FIRE ENGINEER).
- 6. ALL MEANS OF EGRESS, EMERGENCY LIGHTING, EXIT SIGNS, FIRE DOORS, FIRE HYDRANT SYSTEMS, FIRE HOSE REEL SYSTEMS, PORTABLE FIRE EXTINGUISHERS, SMOKE AND HEAT VENTS, SMOKE DETECTION, ALARM AND EXHAUST SYSTEM TO BE IN ACCORDANCE WITH THE BCA AND OTHER RELEVANT AUSTRALIAN STANDARDS.

A 21.07.2022 FOR DA SUBMISSION DESCRIPTION

CHERYL NGUYEN

ARCHITECT

OIC DESIGN PTY LTD. (ABN 89 645 958 247) A1/ 35-39 BURKE ROAD ALEXANDRIA NSW 2015 Ph. 04 5066 1226

PROJECT


17 ANEMBO AVE RESIDENCE

PROPOSED GARAGE PLAN

1:100 @A1	DA300	REVISION
JOB NUMBER	DRAWN BY	DATE
2101	CC	JUL 22



PROJECT ADDRESS 17 ANEMBO AVE GEORGES HALLS NSW

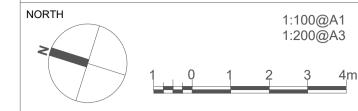


GENERAL NOTES:

- DO NOT SCALE OFF DRAWINGS.
 USE ONLY FIGURED DIMENSIONS.
- 2. ALL DIMENSIONS ARE TO BE VERIFIED ON SITE PRIOR TO COMMENCEMENT OF ANY WORK.
- 3. ANY DISCREPANCIES ARE TO BE BROUGHT TO THE ATTENTION OF OIC DESIGN PTY LTD BEFORE COMMENCEMENT OF ANY WORK.
- 4. ALL DIMENSIONS ARE GIVEN IN MILLIMETRES EXCEPT LEVELS & DRAWINGS TO SCALE 1:500 AND SMALLER WHICH ARE IN METRES.
- 5. THIS DRAWING IS TO BE READ IN CONJUNCTION WITH RELEVANT CONSULTANTS DOCUMENTATION.
- 6. ALL DESIGNS, PRINTS & SPECIFICATIONS ARE THE PROPERTY OF OIC DESIGN PTY LTD &

 MUST NOT BE ISSUED, USED OR REPRODUCED WITHOUT WRITTEN PREMISSION FROM

OIC DESIGN PTY LTD. DA NOTES:

- DRAWINGS ARE TO BE READ IN CONJUNCTION WITH THE DEVELOPMENT APPLICATION FORM AND STATEMENT OF ENVIRONMENTAL EFFECTS.
- 2. THE NEW BUILDING WORK IS TO BE CARRIED OUT IN ACCORDANCE WITH THE PROVISIONS OF THE BCA.
- 3. ALL NEW BUILDING WORK IS TO BE CARRIED OUT IN ACCORDANCE WITH THE NOTICE OF DETERMINATION FOR THIS DEVELOPMENT APPLICATION.
- 4. DISABILITY ACCESS AND FACILITIES TO BE IN ACCORDANCE WITH AS 1428.1 AND AS 1428.4
- 5. THE PROPOSED WORKS WILL ADDRESS FIRE SAFETY MEASURES TO COMPLY WITH THE PERFORMANCE REQUIREMENTS OF THE BCA (EITHER DEEMED TO SATISFY OR ALTERNATIVE SOLUTIONS TO BE PREPARED BY A QUALIFIED FIRE ENGINEER).
- 6. ALL MEANS OF EGRESS, EMERGENCY LIGHTING, EXIT SIGNS, FIRE DOORS, FIRE HYDRANT SYSTEMS, FIRE HOSE REEL SYSTEMS, PORTABLE FIRE EXTINGUISHERS, SMOKE AND HEAT VENTS, SMOKE DETECTION, ALARM AND EXHAUST SYSTEM TO BE IN ACCORDANCE WITH THE BCA AND OTHER RELEVANT AUSTRALIAN STANDARDS.

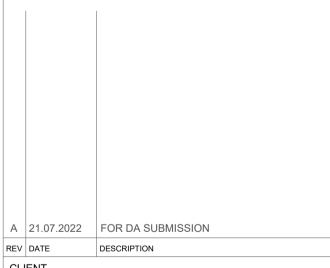

CHERYL NGUYEN

ARCHITECT

OIC DESIGN PTY LTD. (ABN 89 645 958 247) A1/ 35-39 BURKE ROAD ALEXANDRIA NSW 2015 Ph. 04 5066 1226

PROJECT


17 ANEMBO AVE RESIDENCE

PROPOSED GROUND FLOOR PLAN

1:100 @A1	DA301	REVISION
JOB NUMBER	DRAWN BY	DATE
2101	CC	JUL 22



PROJECT ADDRESS 17 ANEMBO AVE **GEORGES HALLS**

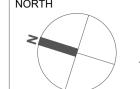

GENERAL NOTES:

- DO NOT SCALE OFF DRAWINGS.
 USE ONLY FIGURED DIMENSIONS.
- 2. ALL DIMENSIONS ARE TO BE VERIFIED ON SITE PRIOR TO COMMENCEMENT OF ANY WORK.
- 3. ANY DISCREPANCIES ARE TO BE BROUGHT TO THE ATTENTION OF OIC DESIGN PTY LTD BEFORE COMMENCEMENT OF ANY WORK.
- 4. ALL DIMENSIONS ARE GIVEN IN MILLIMETRES EXCEPT LEVELS & DRAWINGS TO SCALE 1:500 AND SMALLER WHICH ARE IN METRES.
- 5. THIS DRAWING IS TO BE READ IN CONJUNCTION WITH RELEVANT CONSULTANTS DOCUMENTATION.
- 6. ALL DESIGNS, PRINTS & SPECIFICATIONS ARE THE
- PROPERTY OF OIC DESIGN PTY LTD &
 MUST NOT BE ISSUED, USED OR REPRODUCED
- WITHOUT WRITTEN PREMISSION FROM OIC DESIGN PTY LTD.

DRAWINGS ARE TO BE READ IN CONJUNCTION WITH THE DEVELOPMENT APPLICATION FORM AND STATEMENT OF ENVIRONMENTAL EFFECTS.

- 2. THE NEW BUILDING WORK IS TO BE CARRIED OUT IN ACCORDANCE WITH THE PROVISIONS OF THE BCA.
- 3. ALL NEW BUILDING WORK IS TO BE CARRIED OUT IN ACCORDANCE WITH THE NOTICE OF DETERMINATION
- FOR THIS DEVELOPMENT APPLICATION.
- 4. DISABILITY ACCESS AND FACILITIES TO BE IN ACCORDANCE WITH AS 1428.1 AND AS 1428.4
- 5. THE PROPOSED WORKS WILL ADDRESS FIRE SAFETY MEASURES TO COMPLY WITH THE PERFORMANCE REQUIREMENTS OF THE BCA (EITHER DEEMED TO SATISFY OR ALTERNATIVE SOLUTIONS TO BE PREPARED BY A QUALIFIED FIRE ENGINEER).
- 6. ALL MEANS OF EGRESS, EMERGENCY LIGHTING, EXIT SIGNS, FIRE DOORS, FIRE HYDRANT SYSTEMS, FIRE HOSE REEL SYSTEMS, PORTABLE FIRE EXTINGUISHERS, SMOKE AND HEAT VENTS, SMOKE DETECTION, ALARM AND EXHAUST SYSTEM TO BE IN ACCORDANCE WITH THE BCA AND OTHER RELEVANT AUSTRALIAN STANDARDS.

A 21.07.2022 FOR DA SUBMISSION DESCRIPTION

REV DATE

CHERYL NGUYEN

ARCHITECT

OIC DESIGN PTY LTD. (ABN 89 645 958 247) A1/ 35-39 BURKE ROAD ALEXANDRIA NSW 2015 Ph. 04 5066 1226

PROJECT

17 ANEMBO AVE RESIDENCE

PROPOSED FIRST FLOOR PLAN

SCALE 1:100 @A1	DA302	REVISION
JOB NUMBER	DRAWN BY	DATE
2101	CC	JUL 22




- 5. THIS DRAWING IS TO BE READ IN CONJUNCTION WITH RELEVANT CONSULTANTS DOCUMENTATION.
- 6. ALL DESIGNS, PRINTS & SPECIFICATIONS ARE THE
- PROPERTY OF OIC DESIGN PTY LTD &

 MUST NOT BE ISSUED, USED OR REPRODUCED

- 3. ALL NEW BUILDING WORK IS TO BE CARRIED OUT IN ACCORDANCE WITH THE NOTICE OF DETERMINATION
- FOR THIS DEVELOPMENT APPLICATION.
- ACCORDANCE WITH AS 1428.1 AND AS 1428.4
- 6. ALL MEANS OF EGRESS, EMERGENCY LIGHTING, EXIT SIGNS, FIRE DOORS, FIRE HYDRANT SYSTEMS, FIRE HOSE REEL SYSTEMS, PORTABLE FIRE EXTINGUISHERS, SMOKE AND HEAT VENTS, SMOKE DETECTION, ALARM AND EXHAUST SYSTEM TO BE IN ACCORDANCE WITH THE BCA AND OTHER RELEVANT AUSTRALIAN STANDARDS.

PROPOSED ROOF PLAN


SCALE 1:100 @A1	DA303	REVISION
JOB NUMBER	DRAWN BY	DATE
2101	CC	JUL 22

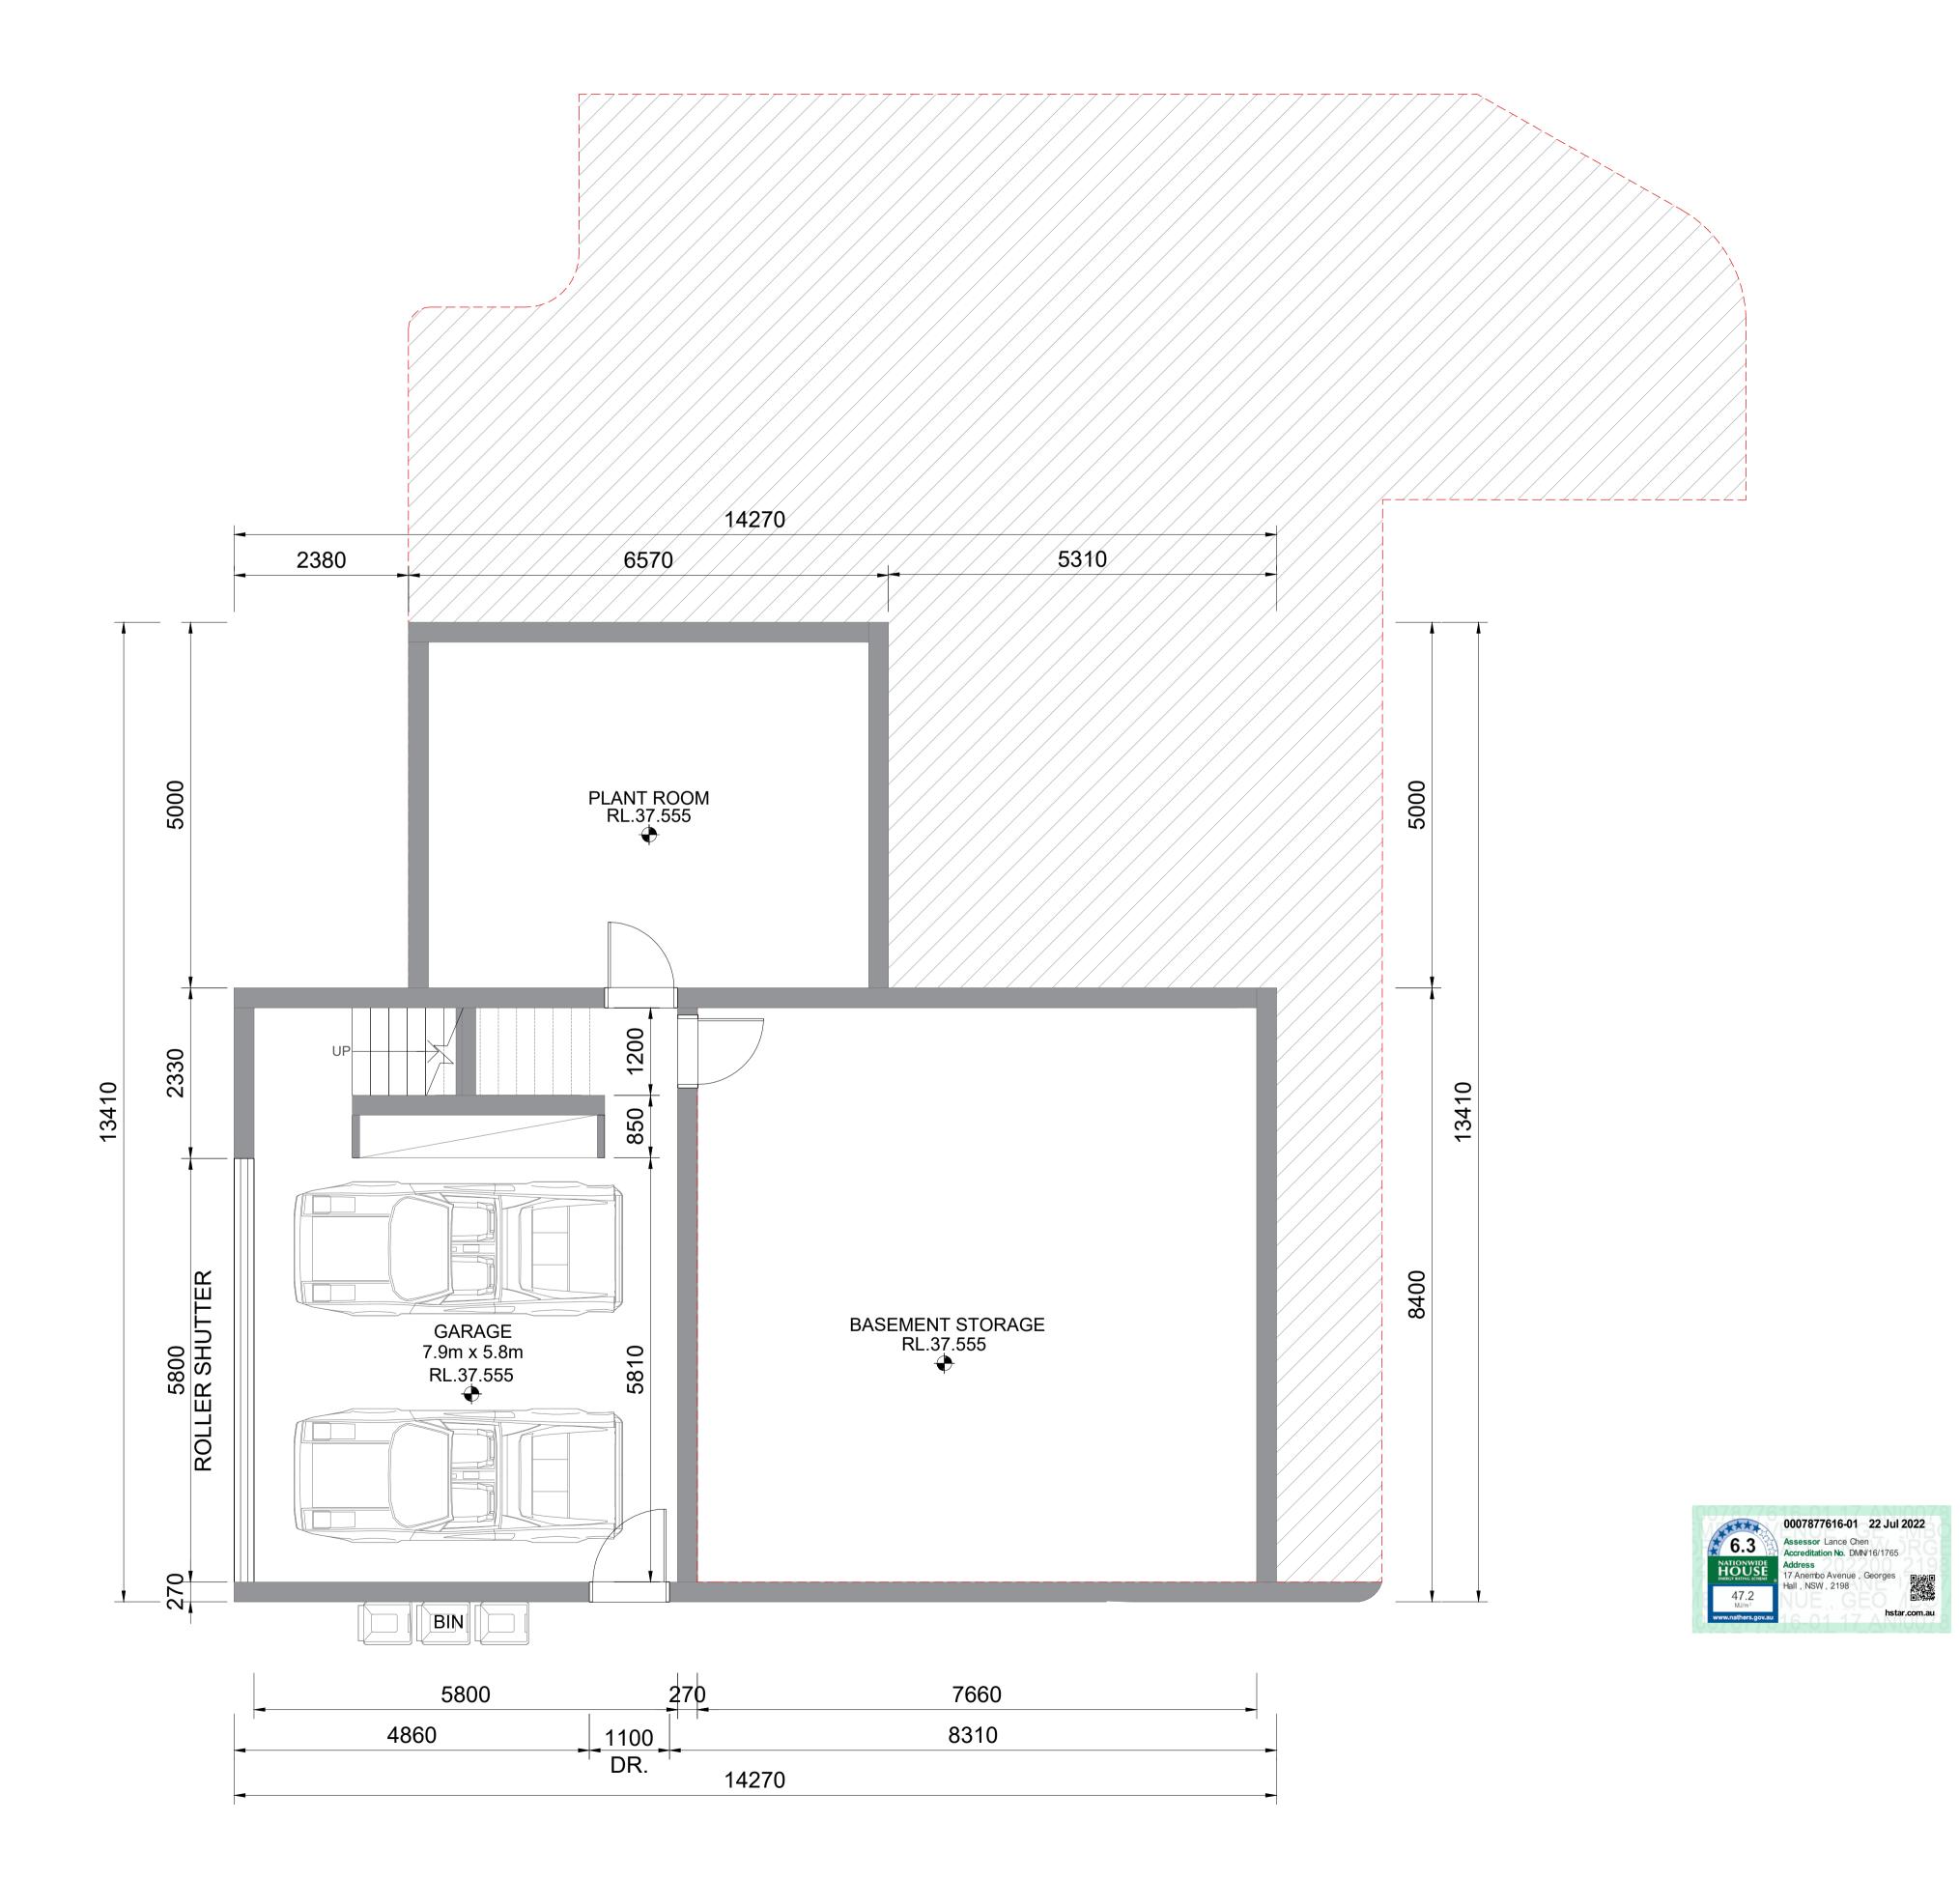

This document should not be relied on or used in circumstances other than those for which it was originally prepared and for which OIC DESIGN was commissioned. OIC DESIGN accepts no responsibility for this document to any other party other than the person by whom it was commissioned

FOR DA SUBMISSION

PROJECT ADDRESS 17 ANEMBO AVE GEORGES HALLS NSW

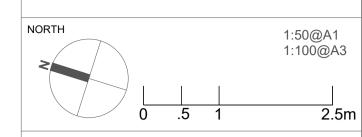

GENERAL NOTES:

- DO NOT SCALE OFF DRAWINGS.
 USE ONLY FIGURED DIMENSIONS.
- 2. ALL DIMENSIONS ARE TO BE VERIFIED ON SITE PRIOR TO COMMENCEMENT OF ANY WORK.
- 3. ANY DISCREPANCIES ARE TO BE BROUGHT TO THE ATTENTION OF OIC DESIGN PTY LTD BEFORE COMMENCEMENT OF ANY WORK.
- 4. ALL DIMENSIONS ARE GIVEN IN MILLIMETRES EXCEPT LEVELS & DRAWINGS TO SCALE 1:500 AND SMALLER WHICH ARE IN METRES.
- 5. THIS DRAWING IS TO BE READ IN CONJUNCTION WITH RELEVANT CONSULTANTS DOCUMENTATION.
- 6. ALL DESIGNS, PRINTS & SPECIFICATIONS ARE THE PROPERTY OF OIC DESIGN PTY LTD &

 MUST NOT BE ISSUED, USED OR REPRODUCED
- WITHOUT WRITTEN PREMISSION FROM OIC DESIGN PTY LTD.

DA NOTES:

- DRAWINGS ARE TO BE READ IN CONJUNCTION WITH THE DEVELOPMENT APPLICATION FORM AND STATEMENT OF ENVIRONMENTAL EFFECTS.
- 2. THE NEW BUILDING WORK IS TO BE CARRIED OUT IN ACCORDANCE WITH THE PROVISIONS OF THE BCA.
- 3. ALL NEW BUILDING WORK IS TO BE CARRIED OUT IN ACCORDANCE WITH THE NOTICE OF DETERMINATION
- FOR THIS DEVELOPMENT APPLICATION. 4. DISABILITY ACCESS AND FACILITIES TO BE IN
- ACCORDANCE WITH AS 1428.1 AND AS 1428.4
- 5. THE PROPOSED WORKS WILL ADDRESS FIRE SAFETY MEASURES TO COMPLY WITH THE PERFORMANCE REQUIREMENTS OF THE BCA (EITHER DEEMED TO SATISFY OR ALTERNATIVE SOLUTIONS TO BE

PREPARED BY A QUALIFIED FIRE ENGINEER).

6. ALL MEANS OF EGRESS, EMERGENCY LIGHTING, EXIT SIGNS, FIRE DOORS, FIRE HYDRANT SYSTEMS, FIRE HOSE REEL SYSTEMS, PORTABLE FIRE EXTINGUISHERS, SMOKE AND HEAT VENTS, SMOKE DETECTION, ALARM AND EXHAUST SYSTEM TO BE IN ACCORDANCE WITH THE BCA AND OTHER RELEVANT AUSTRALIAN STANDARDS.

A 21.07.2022 FOR DA SUBMISSION

REV DATE DESCRIPTION

CLIENT

CHERYL NGUYEN

ARCHITECT OIC


OIC DESIGN PTY LTD. (ABN 89 645 958 247) A1/ 35-39 BURKE ROAD ALEXANDRIA NSW 2015 Ph. 04 5066 1226

PROJECT

17 ANEMBO AVE RESIDENCE


PROPOSED DIMENSION GARAGE

SCALE 1:50 @A1	DA400	REVISION
JOB NUMBER	DRAWN BY	DATE
2101	CC	JUL 22

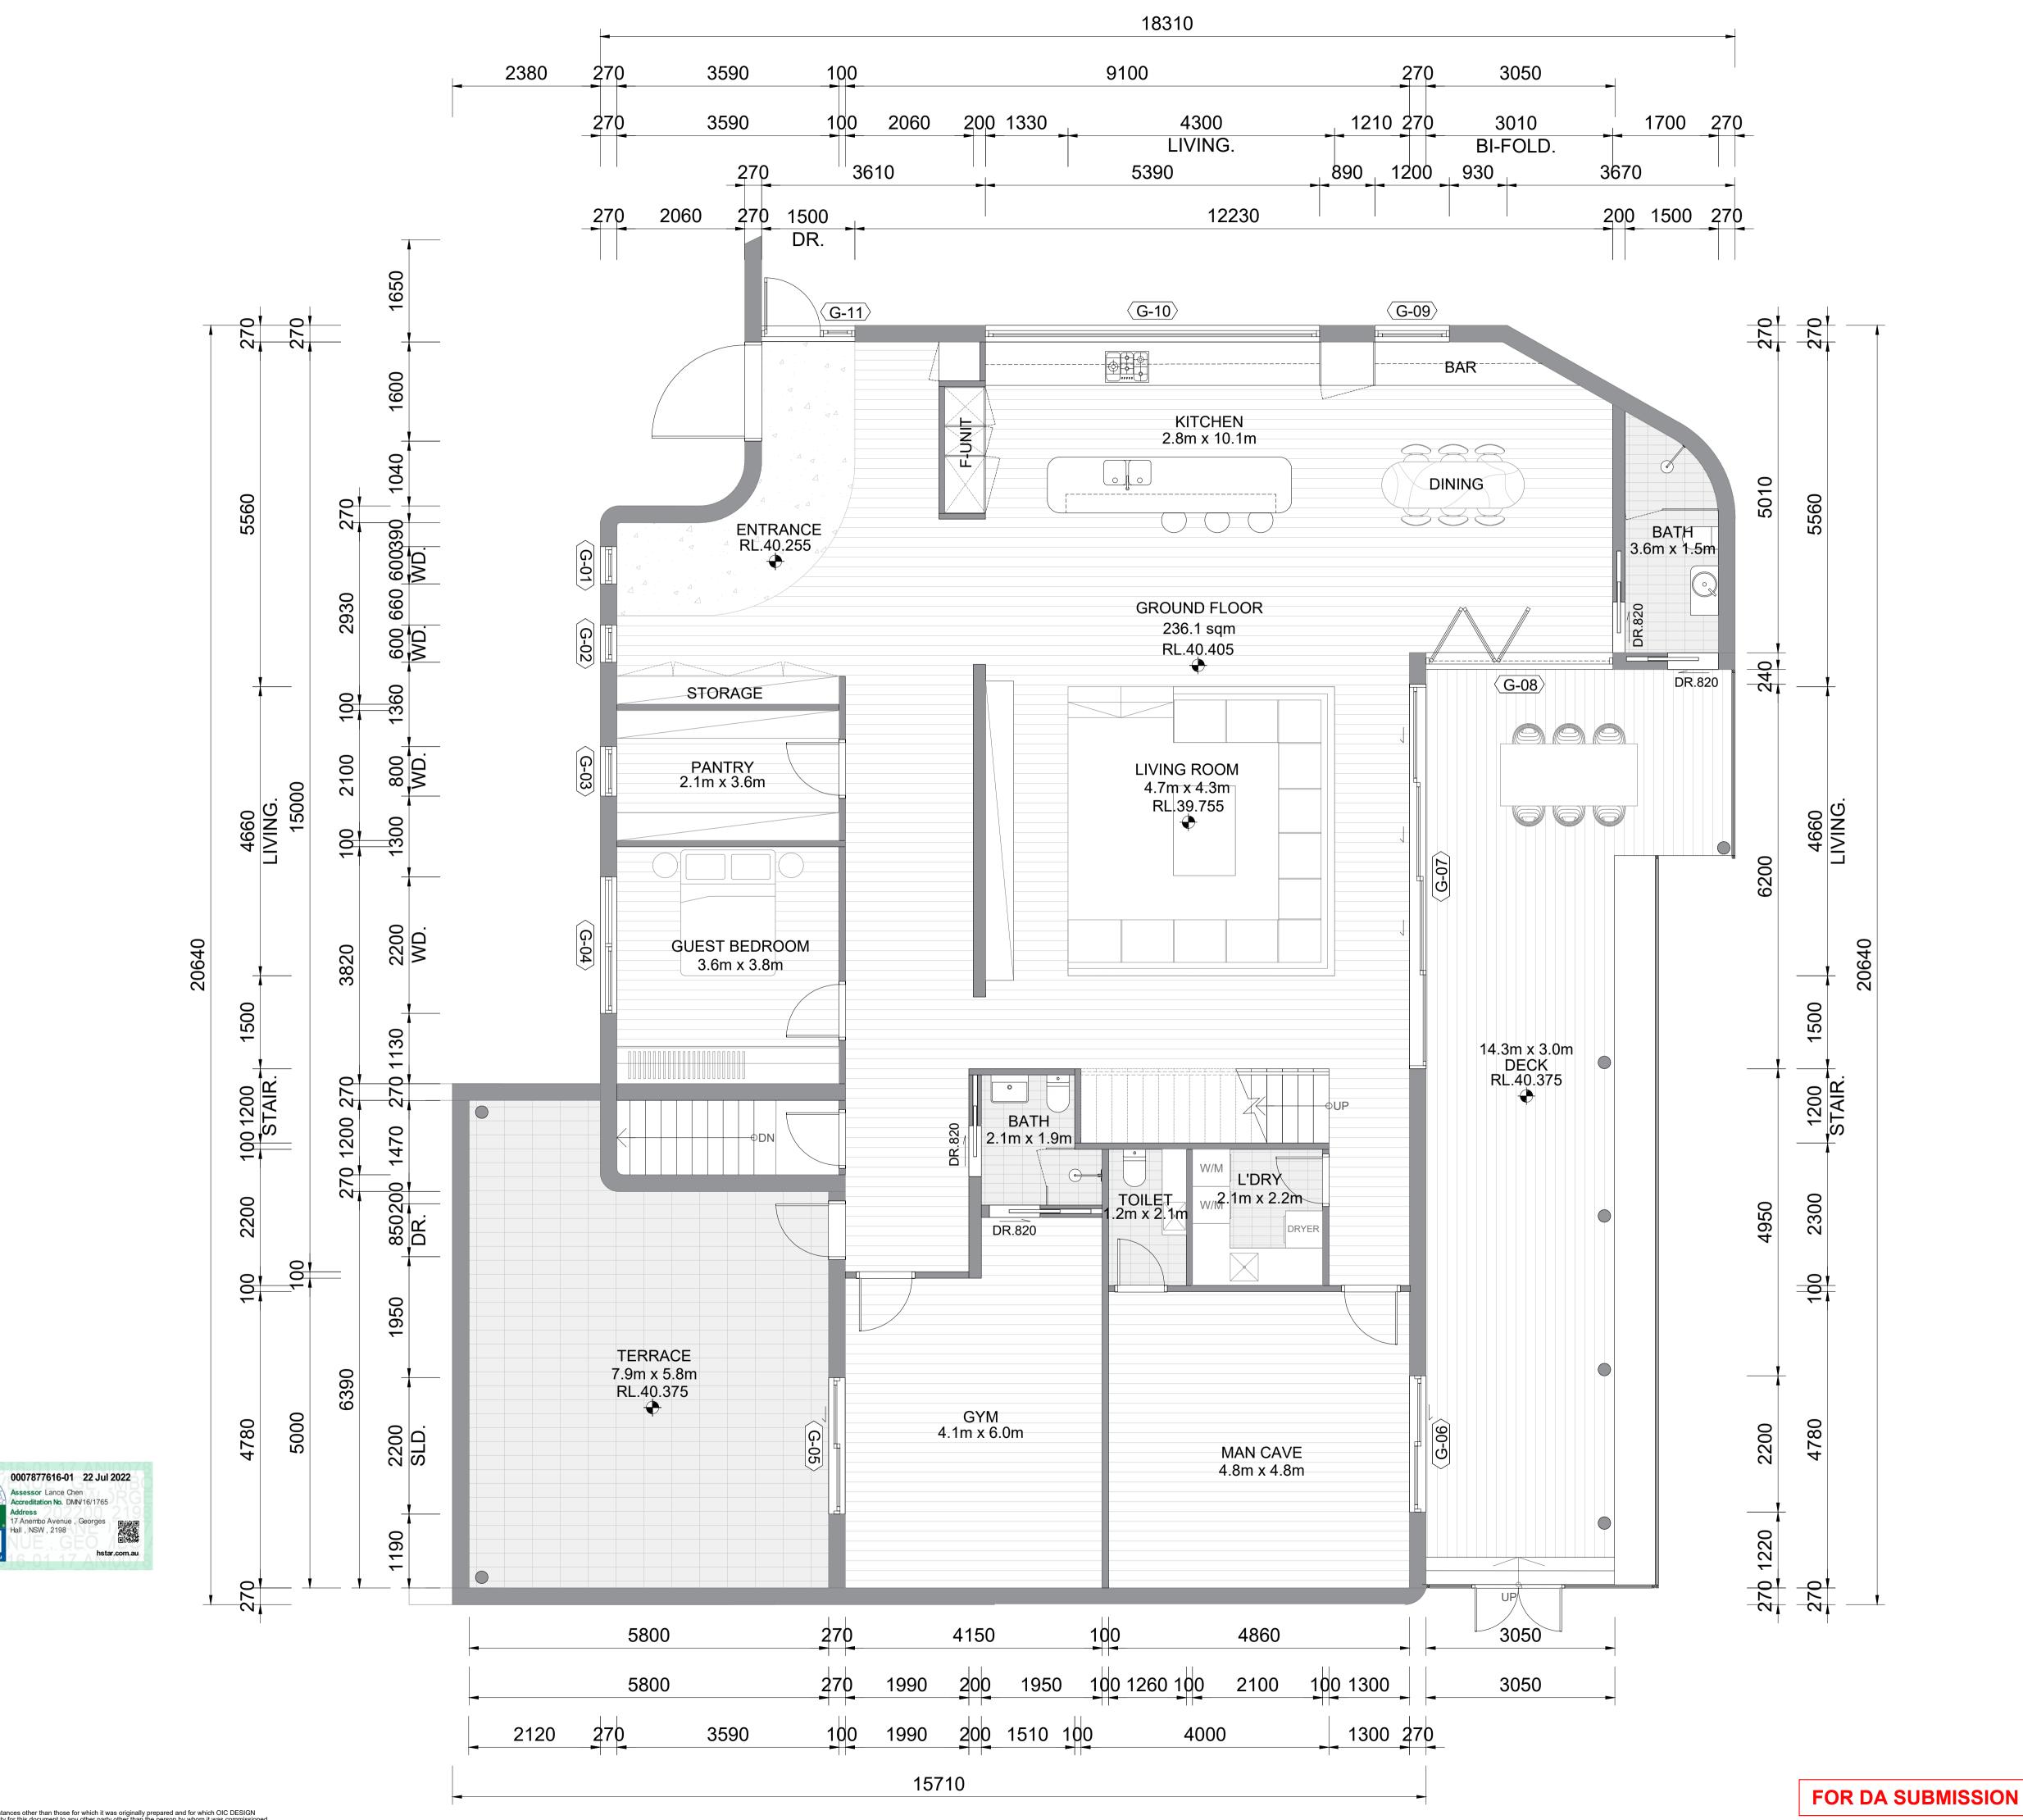

PROJECT ADDRESS 17 ANEMBO AVE **GEORGES HALLS**

NSW

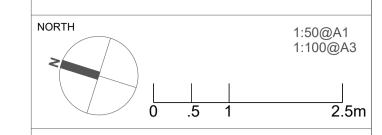

GENERAL NOTES:

1. DO NOT SCALE OFF DRAWINGS.

USE ONLY FIGURED DIMENSIONS.

SMALLER WHICH ARE IN METRES.

- 2. ALL DIMENSIONS ARE TO BE VERIFIED ON SITE PRIOR TO COMMENCEMENT OF ANY WORK.
- 3. ANY DISCREPANCIES ARE TO BE BROUGHT TO THE ATTENTION OF OIC DESIGN PTY LTD BEFORE COMMENCEMENT OF ANY WORK.
- 4. ALL DIMENSIONS ARE GIVEN IN MILLIMETRES EXCEPT LEVELS & DRAWINGS TO SCALE 1:500 AND
- 5. THIS DRAWING IS TO BE READ IN CONJUNCTION WITH RELEVANT CONSULTANTS DOCUMENTATION.
- 6. ALL DESIGNS, PRINTS & SPECIFICATIONS ARE THE PROPERTY OF OIC DESIGN PTY LTD &
- MUST NOT BE ISSUED, USED OR REPRODUCED WITHOUT WRITTEN PREMISSION FROM OIC DESIGN PTY LTD.

- 1. DRAWINGS ARE TO BE READ IN CONJUNCTION WITH THE DEVELOPMENT APPLICATION FORM AND STATEMENT OF ENVIRONMENTAL EFFECTS.
- 2. THE NEW BUILDING WORK IS TO BE CARRIED OUT IN ACCORDANCE WITH THE PROVISIONS OF THE BCA.
- 3. ALL NEW BUILDING WORK IS TO BE CARRIED OUT IN ACCORDANCE WITH THE NOTICE OF DETERMINATION FOR THIS DEVELOPMENT APPLICATION.
- 4. DISABILITY ACCESS AND FACILITIES TO BE IN ACCORDANCE WITH AS 1428.1 AND AS 1428.4
- 5. THE PROPOSED WORKS WILL ADDRESS FIRE SAFETY MEASURES TO COMPLY WITH THE PERFORMANCE REQUIREMENTS OF THE BCA (EITHER DEEMED TO SATISFY OR ALTERNATIVE SOLUTIONS TO BE PREPARED BY A QUALIFIED FIRE ENGINEER).
- 6. ALL MEANS OF EGRESS, EMERGENCY LIGHTING, EXIT SIGNS, FIRE DOORS, FIRE HYDRANT SYSTEMS, FIRE HOSE REEL SYSTEMS, PORTABLE FIRE EXTINGUISHERS, SMOKE AND HEAT VENTS, SMOKE DETECTION, ALARM AND EXHAUST SYSTEM TO BE IN ACCORDANCE WITH THE BCA AND OTHER RELEVANT AUSTRALIAN STANDARDS.

A 21.07.2022 FOR DA SUBMISSION

DESCRIPTION

CHERYL NGUYEN

ARCHITECT OIC

OIC DESIGN PTY LTD. (ABN 89 645 958 247) A1/ 35-39 BURKE ROAD ALEXANDRIA NSW 2015 Ph. 04 5066 1226

PROJECT

17 ANEMBO AVE RESIDENCE


PROPOSED DIMENSION GROUND FLOOR

1:50 @A1	DRAWING NO.	REVISION
JOB NUMBER	DRAWN BY	DATE
2101	CC	Jul 22

0007877616-01 22 Jul 2022

Assessor Lance Chen Accreditation No. DMN/16/1765

6.3

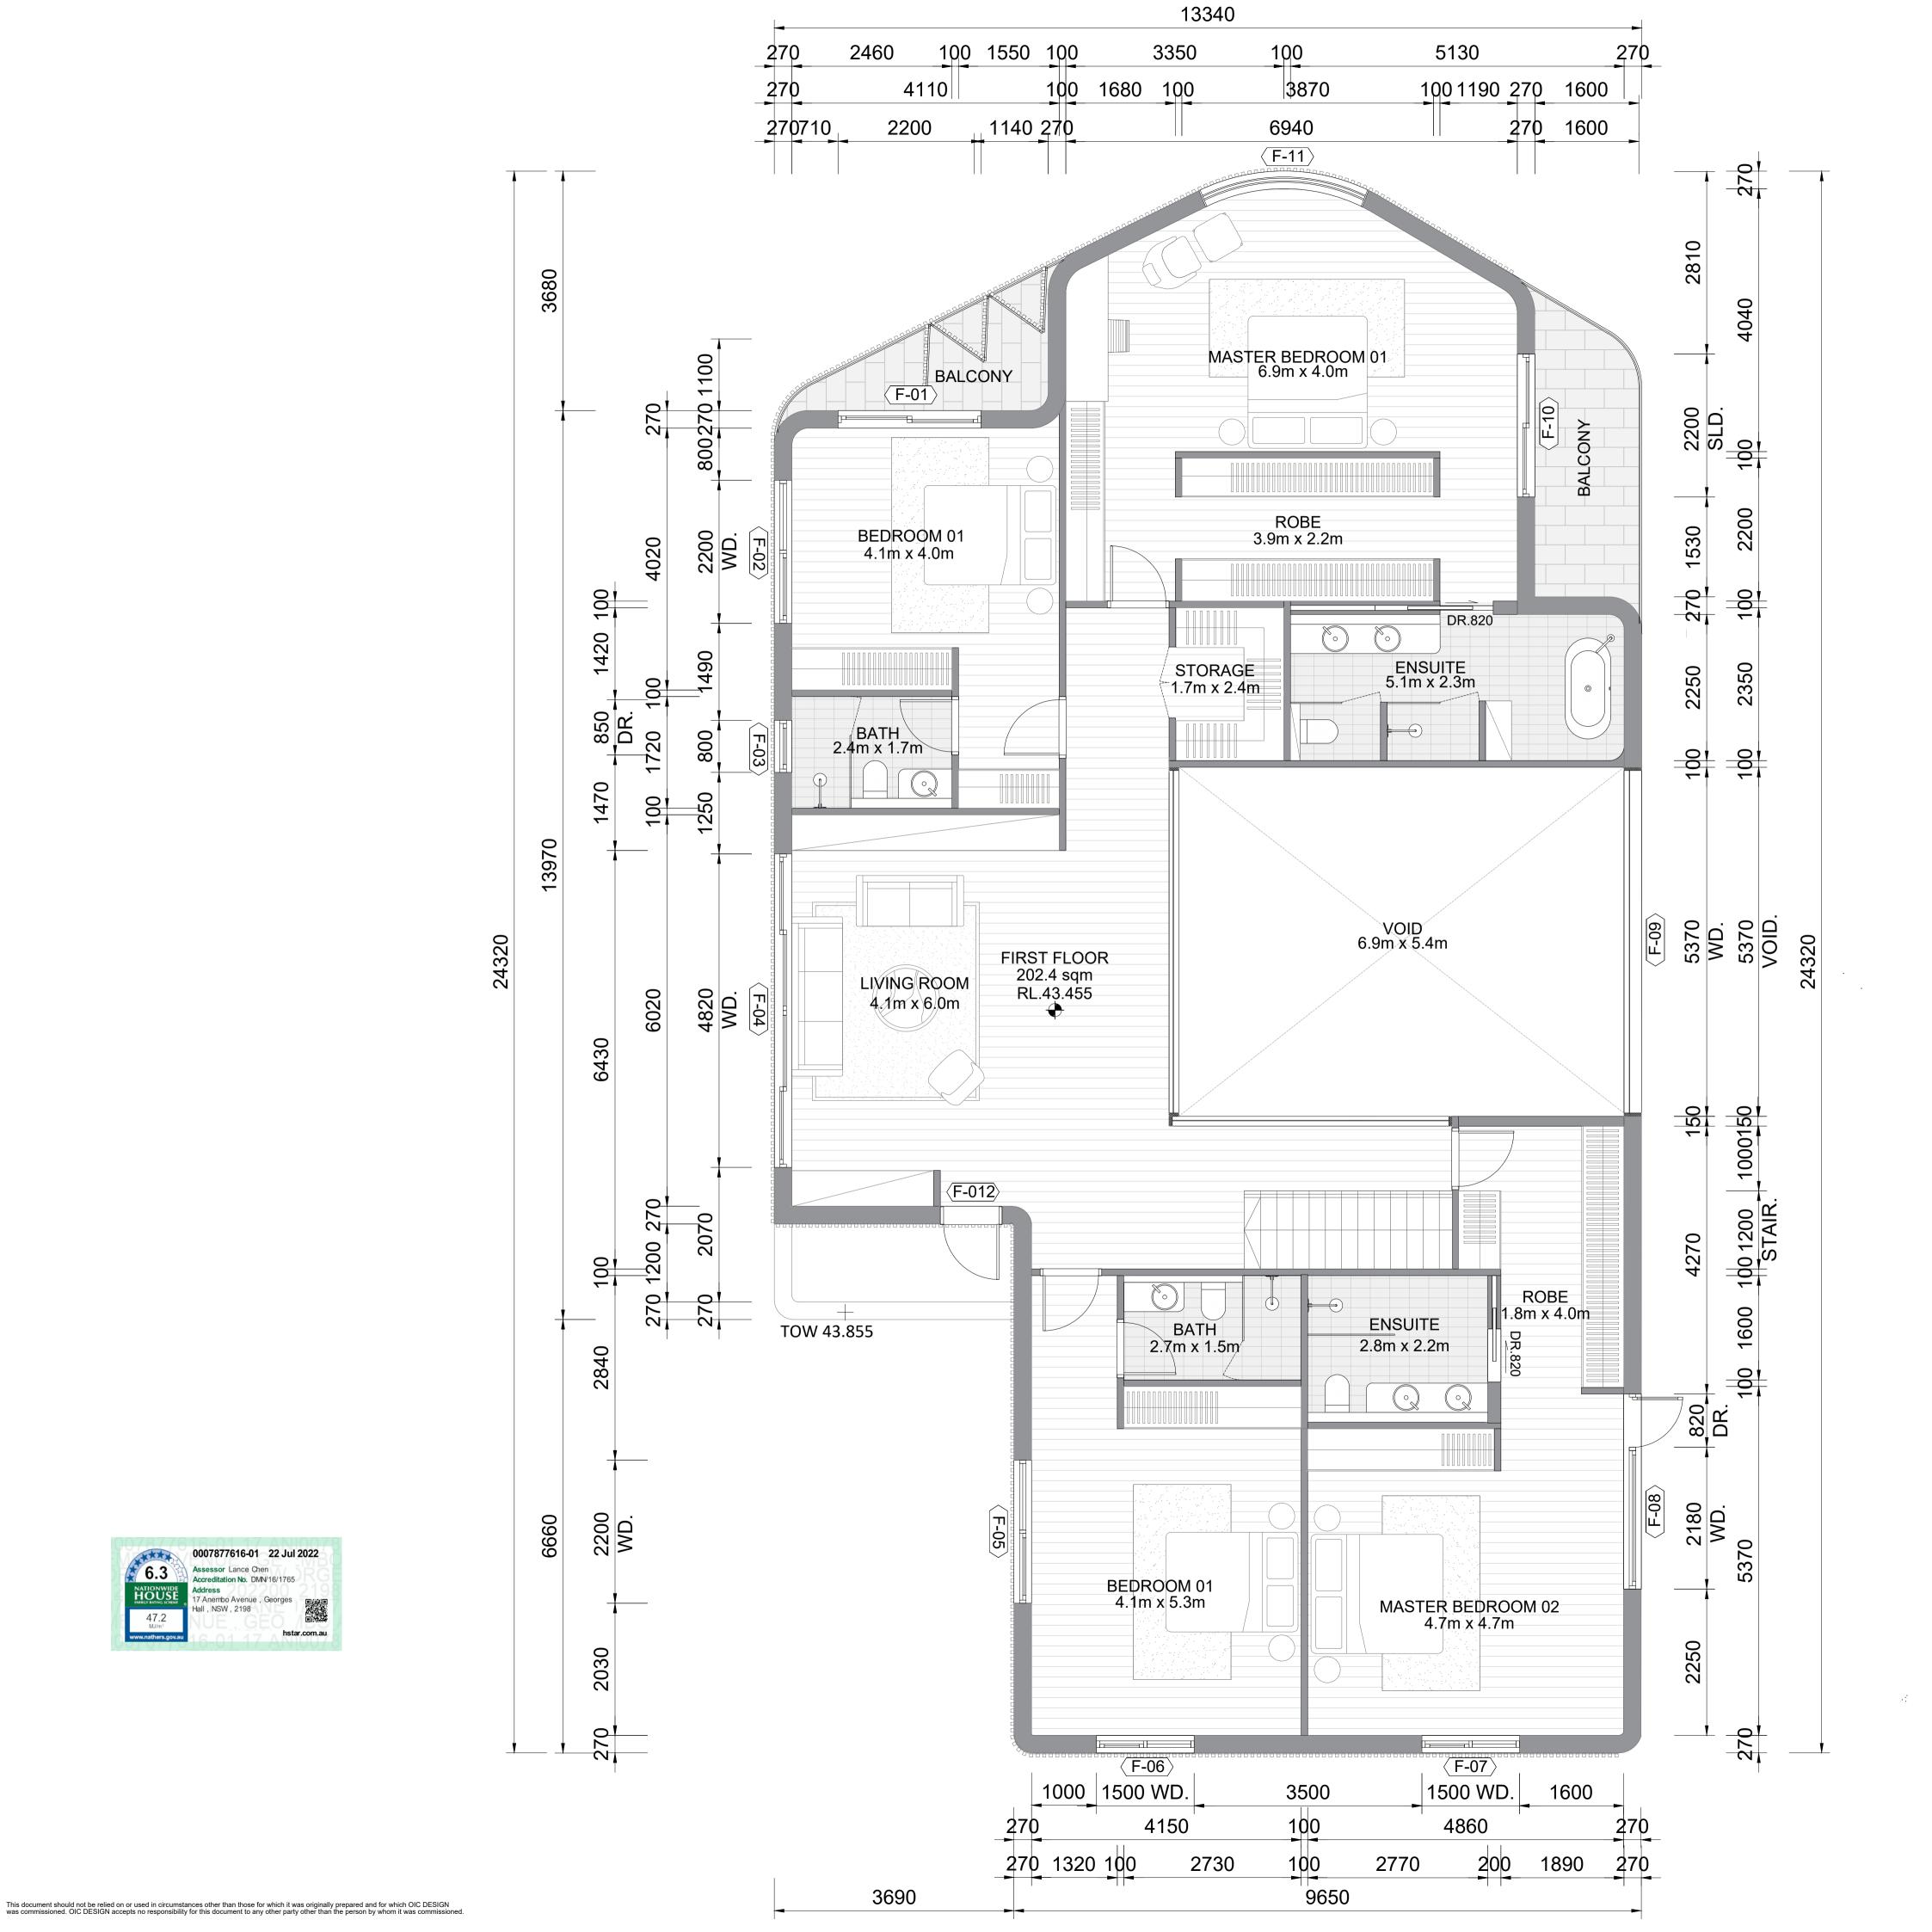

0007877616-01 22 Jul 2022

Address
17 Anembo Avenue , Georges
Hall , NSW , 2198


Assessor Lance Chen Accreditation No. DMN/16/1765

6.3

PROJECT ADDRESS

17 ANEMBO AVE **GEORGES HALLS**

NSW

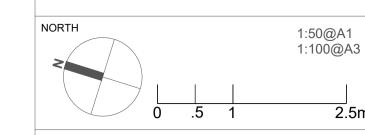

GENERAL NOTES:

DO NOT SCALE OFF DRAWINGS.
 USE ONLY FIGURED DIMENSIONS.

- 2. ALL DIMENSIONS ARE TO BE VERIFIED ON SITE PRIOR TO
- COMMENCEMENT OF ANY WORK.
- 3. ANY DISCREPANCIES ARE TO BE BROUGHT TO THE ATTENTION OF OIC DESIGN PTY LTD BEFORE COMMENCEMENT OF ANY WORK.
- 4. ALL DIMENSIONS ARE GIVEN IN MILLIMETRES EXCEPT LEVELS & DRAWINGS TO SCALE 1:500 AND SMALLER WHICH ARE IN METRES. 5. THIS DRAWING IS TO BE READ IN CONJUNCTION
- WITH RELEVANT CONSULTANTS DOCUMENTATION.
- ALL DESIGNS, PRINTS & SPECIFICATIONS ARE THE PROPERTY OF OIC DESIGN PTY LTD & MUST NOT BE ISSUED, USED OR REPRODUCED WITHOUT WRITTEN PREMISSION FROM

DA NOTES:

OIC DESIGN PTY LTD.

- 1. DRAWINGS ARE TO BE READ IN CONJUNCTION WITH THE DEVELOPMENT APPLICATION FORM AND STATEMENT OF ENVIRONMENTAL EFFECTS.
- 2. THE NEW BUILDING WORK IS TO BE CARRIED OUT IN ACCORDANCE WITH THE PROVISIONS OF THE BCA.
- 3. ALL NEW BUILDING WORK IS TO BE CARRIED OUT IN ACCORDANCE WITH THE NOTICE OF DETERMINATION FOR THIS DEVELOPMENT APPLICATION.
- 4. DISABILITY ACCESS AND FACILITIES TO BE IN
- ACCORDANCE WITH AS 1428.1 AND AS 1428.4
- 5. THE PROPOSED WORKS WILL ADDRESS FIRE SAFETY MEASURES TO COMPLY WITH THE PERFORMANCE REQUIREMENTS OF THE BCA (EITHER DEEMED TO SATISFY OR ALTERNATIVE SOLUTIONS TO BE PREPARED BY A QUALIFIED FIRE ENGINEER).
- 6. ALL MEANS OF EGRESS, EMERGENCY LIGHTING, EXIT SIGNS, FIRE DOORS, FIRE HYDRANT SYSTEMS, FIRE HOSE REEL SYSTEMS, PORTABLE FIRE EXTINGUISHERS, SMOKE AND HEAT VENTS, SMOKE DETECTION, ALARM AND EXHAUST SYSTEM TO BE IN ACCORDANCE WITH THE BCA AND OTHER RELEVANT AUSTRALIAN STANDARDS.

A 21.07.2022 FOR DA SUBMISSION

REV DATE DESCRIPTION

CHERYL NGUYEN

ARCHITECT OIC

OIC DESIGN PTY LTD. (ABN 89 645 958 247) A1/ 35-39 BURKE ROAD ALEXANDRIA NSW 2015

Ph. 04 5066 1226 PROJECT

CLIENT


17 ANEMBO AVE RESIDENCE

PROPOSED DIMENSION FIRST FLOOR

SCALE 1:50 @A1	DA402	REVISION
JOB NUMBER	DRAWN BY	DATE
2101	CC	JUL 22

FOR DA SUBMISSION



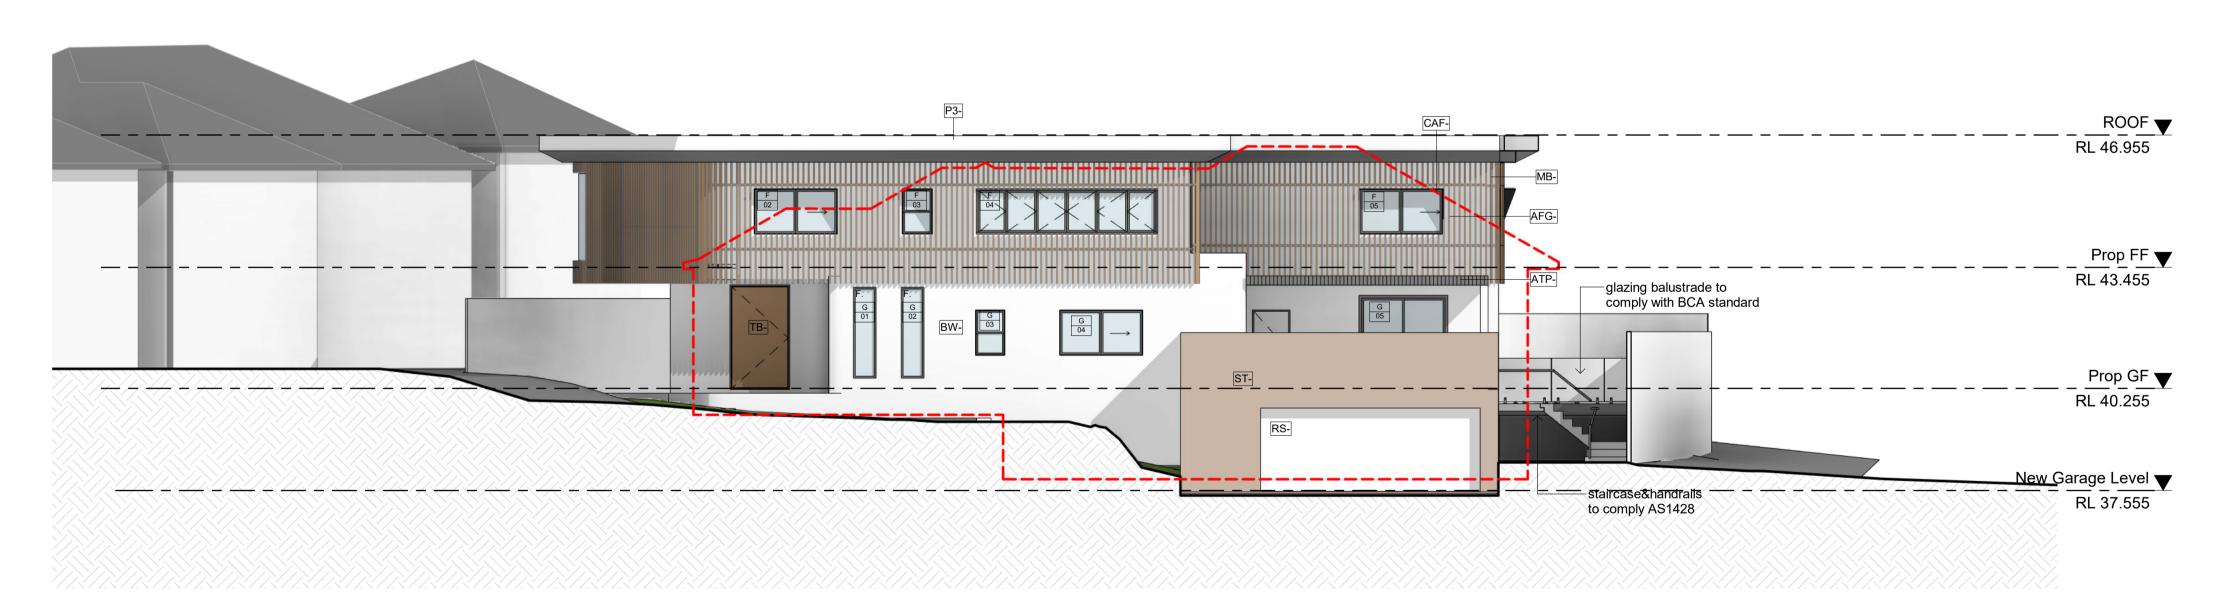

ELEVATIONS NORTH WEST ELEVATION

ELEVATIONS

FRONT ELEVATION

SCALE 1:100

SCALE 1:100



EXTERNAL FINISHES

AFG- ALUMINUM FRAME GLAZING

ATP- ALUMINUM TIMBER LOOK PERGOLA

TEXTURE RENDERED WALL

CUTOMIZED ALUMINUM FRAME

METAL BATTEN SCREEN

RENDERED AWNING

ROLLER SHUTTER ST-

SANDSTONE CLADDING CUTOMIZED TIMBER DOOR

> ALL LEVELS ARE INDICATIVE AND TO BE COORDINATED WITH CIVIL ENGINEER'S FUTURE DETAILS AND EARTHWORKS. ALL LEVEL ARE TO BE +/- 500 mm.

FOR DA SUBMISSION

PROJECT ADDRESS 17 ANEMBO AVE, GEORGES HALL, NSW 2198

GENERAL NOTES:

DO NOT SCALE OFF DRAWINGS.
 USE ONLY FIGURED DIMENSIONS.

2. ALL DIMENSIONS ARE TO BE VERIFIED ON SITE PRIOR TO COMMENCEMENT OF ANY WORK.

3. ANY DISCREPANCIES ARE TO BE BROUGHT TO THE ATTENTION OF OIC DESIGN PTY LTD BEFORE COMMENCEMENT OF ANY WORK.

4. ALL DIMENSIONS ARE GIVEN IN MILLIMETRES EXCEPT LEVELS & DRAWINGS TO SCALE 1:500 AND SMALLER WHICH ARE IN METRES.

5. THIS DRAWING IS TO BE READ IN CONJUNCTION

WITH RELEVANT CONSULTANTS DOCUMENTATION.

6. ALL DESIGNS, PRINTS & SPECIFICATIONS ARE THE PROPERTY OF OIC DESIGN PTY LTD & MUST NOT BE ISSUED, USED OR REPRODUCED WITHOUT WRITTEN PREMISSION FROM OIC DESIGN PTY LTD.

DA NOTES:

. DRAWINGS ARE TO BE READ IN CONJUNCTION WITH THE DEVELOPMENT APPLICATION FORM AND STATEMENT OF ENVIRONMENTAL EFFECTS.


2. THE NEW BUILDING WORK IS TO BE CARRIED OUT IN ACCORDANCE WITH THE PROVISIONS OF THE BCA. 3. ALL NEW BUILDING WORK IS TO BE CARRIED OUT IN

ACCORDANCE WITH THE NOTICE OF DETERMINATION FOR THIS DEVELOPMENT APPLICATION.

. DISABILITY ACCESS AND FACILITIES TO BE IN ACCORDANCE WITH AS 1428.1 AND AS 1428.4

5. THE PROPOSED WORKS WILL ADDRESS FIRE SAFETY MEASURES TO COMPLY WITH THE PERFORMANCE REQUIREMENTS OF THE BCA (EITHER DEEMED TO SATISFY OR ALTERNATIVE SOLUTIONS TO BE PREPARED BY A QUALIFIED FIRE ENGINEER).

3. ALL MEANS OF EGRESS, EMERGENCY LIGHTING, EXIT SIGNS, FIRE DOORS, FIRE HYDRANT SYSTEMS, FIRE HOSE REEL SYSTEMS, PORTABLE FIRE EXTINGUISHERS, SMOKE AND HEAT VENTS, SMOKE DETECTION, ALARM AND EXHAUST SYSTEM TO BE IN ACCORDANCE WITH THE BCA AND OTHER RELEVANT AUSTRALIAN STANDARDS.

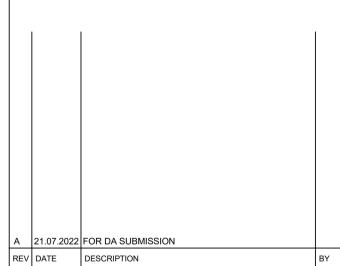

CLIENT CHERYL NGUYEN

BUILDING DESIGNER

OIC

OIC DESIGN PTY LTD. (ABN 89 645 958 247) A1/ 35-39 BURKE ROAD ALEXANDRIA NSW 2015 Ph. 04 5066 1226


PROJECT


17 ANEMBO AVE, GEORGES HALL, NSW 2198

ELEVATIONS

DRAWING NO. REVISION SCALE 1:100 @ A1 DA- 500

JOB NUMBER DRAWN BY 2101 JUL 22 CC

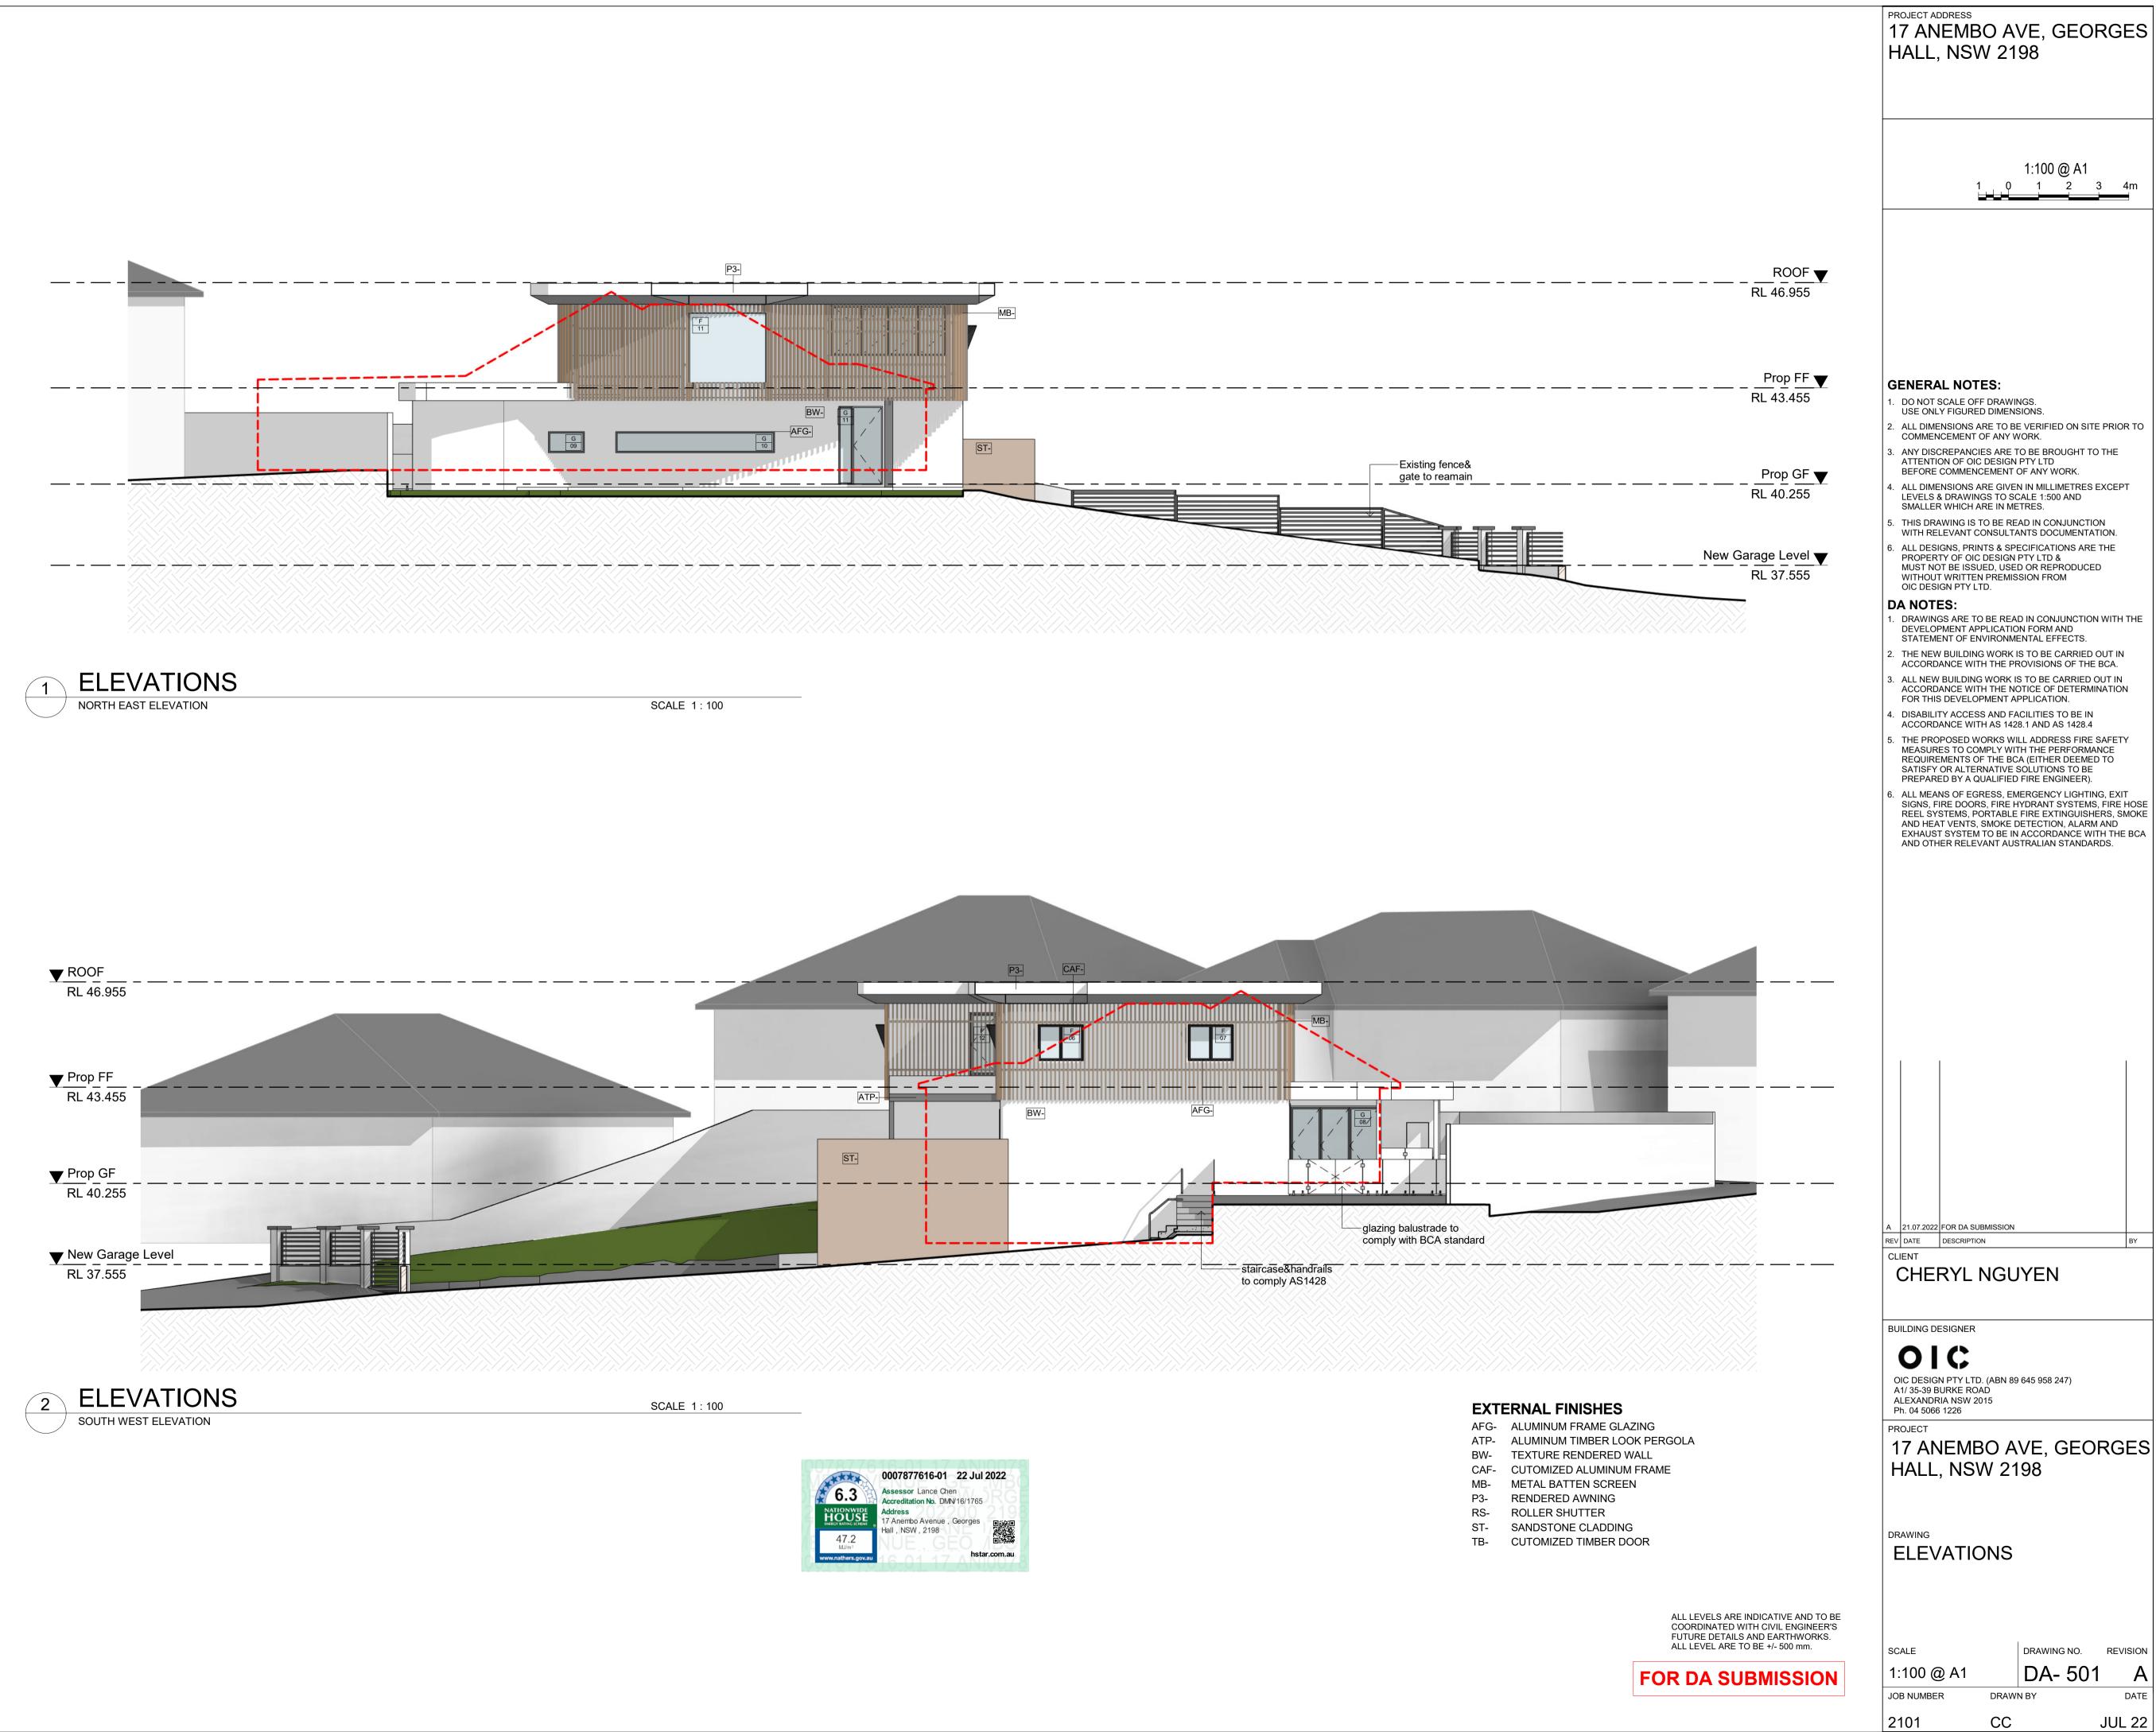

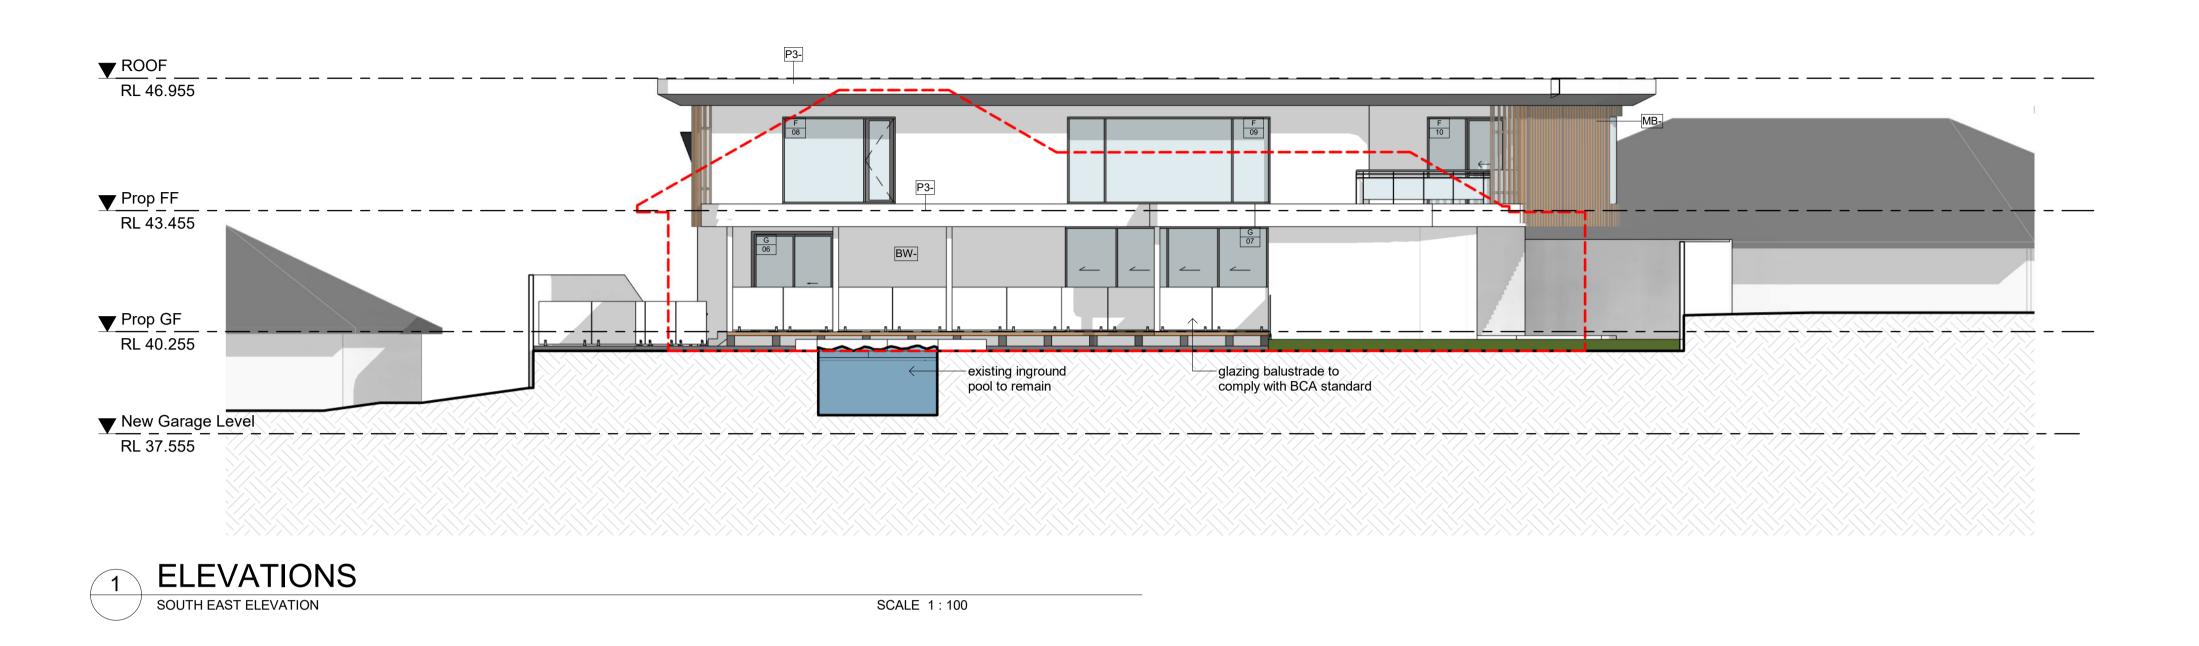

BASIX Thermal Specification – 17 Anemo Ave, Georges Hall NSW

Element	Construction	Details	
Roof / Ceiling		Medium colour (0.475≤Solar Absorptance≤0.7)	
	Concrete flat roof + Plasterboard (PB) ceiling without insulation	Applicable to the exposed roof over the basement floor	
	Concrete flat roof + R3.5 bulk insulation + PB	Applicable to the exposed roof over the ground floor and roof over the first floor	
Internal ceiling	Concrete slab + PB ceiling without insulation	Applicable to all the internal ceilings	
External walls	Concrete walls without insulation	Applicable to the retaining walls on the basement floo	
	Double Brick walls without insulation	Light colour (Solar Absorptance<0.475) Applicable to the other external walls on the basement floor except for the above and the external walls forming the staircase on the ground floor	
	Double Brick + R1.0 bulk insulation + PB	Applicable to all other external walls except those for the above	
Internal walls	Concrete walls without insulation	Applicable to the internal walls at the basement	
	Concrete block walls without insulation	Applicable to the internal walls forming staircase at the ground floor	
	Single brick walls without insulation	Applicable to the other internal walls except those for the above	
Windows	Aluminium frame, weather stripping fitted, single low-e glazed, high solar gain	Applicable to all the windows and glazed doors NFRC glazing system (Glass+Frame) values – Group A (hinged door type): U = 5.4 and SHGC = 0.49; Group B (fixed, sliding and double hung types): U = 5.4 and SHGC = 0.58;	
	Note that all glazing installed shall have the U values values within +/- 10% of those specified above.	not more than those specified above and the SHGC	
Skylights (rooflights)	Standard aluminium frame, weather stripping fitted, double glazed, clear	As per plans	
Floors	Concrete slab on ground without insulation	Applicable to the basement floor and part of the ground floor	
	Suspended concrete floor without insulation	Applicable to the first floor and part of the ground floor (where above the basement)	
	Floor coverings	Living areas: timber; Kitchen and all wet areas: tile; Bedrooms: carpet; Basement: bare concrete	
Downlights	If to be planned, IC rated LED downlights recommended to be used throughout	Rating without downlights due to lighting layout plans / RCPs not available at the current stage.	
		Rating with downlights (if planned) shall be required when lighting layout design is completed prior to application of construction certificate.	



EXTERNAL FINISHES

AFG- ALUMINUM FRAME GLAZING ATP- ALUMINUM TIMBER LOOK PERGOLA BW- TEXTURE RENDERED WALL CAF- CUTOMIZED ALUMINUM FRAME

METAL BATTEN SCREEN

RENDERED AWNING **ROLLER SHUTTER**

SANDSTONE CLADDING ST-CUTOMIZED TIMBER DOOR

> ALL LEVELS ARE INDICATIVE AND TO BE COORDINATED WITH CIVIL ENGINEER'S FUTURE DETAILS AND EARTHWORKS. ALL LEVEL ARE TO BE +/- 500 mm.

FOR DA SUBMISSION

PROJECT ADDRESS 17 ANEMBO AVE, GEORGES HALL, NSW 2198


GENERAL NOTES:

- DO NOT SCALE OFF DRAWINGS.
 USE ONLY FIGURED DIMENSIONS.
- 2. ALL DIMENSIONS ARE TO BE VERIFIED ON SITE PRIOR TO COMMENCEMENT OF ANY WORK.
- 3. ANY DISCREPANCIES ARE TO BE BROUGHT TO THE ATTENTION OF OIC DESIGN PTY LTD BEFORE COMMENCEMENT OF ANY WORK.
- ALL DIMENSIONS ARE GIVEN IN MILLIMETRES EXCEPT LEVELS & DRAWINGS TO SCALE 1:500 AND SMALLER WHICH ARE IN METRES.
- . THIS DRAWING IS TO BE READ IN CONJUNCTION WITH RELEVANT CONSULTANTS DOCUMENTATION.
- 6. ALL DESIGNS, PRINTS & SPECIFICATIONS ARE THE PROPERTY OF OIC DESIGN PTY LTD & MUST NOT BE ISSUED, USED OR REPRODUCED WITHOUT WRITTEN PREMISSION FROM

DA NOTES:

OIC DESIGN PTY LTD.

- DRAWINGS ARE TO BE READ IN CONJUNCTION WITH THE DEVELOPMENT APPLICATION FORM AND STATEMENT OF ENVIRONMENTAL EFFECTS.
- 2. THE NEW BUILDING WORK IS TO BE CARRIED OUT IN ACCORDANCE WITH THE PROVISIONS OF THE BCA.
- 3. ALL NEW BUILDING WORK IS TO BE CARRIED OUT IN ACCORDANCE WITH THE NOTICE OF DETERMINATION FOR THIS DEVELOPMENT APPLICATION.
- . DISABILITY ACCESS AND FACILITIES TO BE IN ACCORDANCE WITH AS 1428.1 AND AS 1428.4
- 5. THE PROPOSED WORKS WILL ADDRESS FIRE SAFETY MEASURES TO COMPLY WITH THE PERFORMANCE REQUIREMENTS OF THE BCA (EITHER DEEMED TO SATISFY OR ALTERNATIVE SOLUTIONS TO BE PREPARED BY A QUALIFIED FIRE ENGINEER).
- 3. ALL MEANS OF EGRESS, EMERGENCY LIGHTING, EXIT SIGNS, FIRE DOORS, FIRE HYDRANT SYSTEMS, FIRE HOSE REEL SYSTEMS, PORTABLE FIRE EXTINGUISHERS, SMOKE AND HEAT VENTS, SMOKE DETECTION, ALARM AND EXHAUST SYSTEM TO BE IN ACCORDANCE WITH THE BCA AND OTHER RELEVANT AUSTRALIAN STANDARDS.

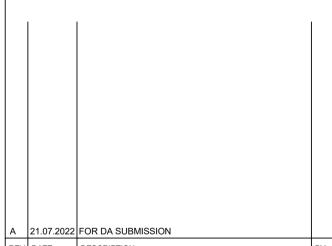

REV DATE DESCRIPTION

CHERYL NGUYEN

BUILDING DESIGNER

OIC DESIGN PTY LTD. (ABN 89 645 958 247) A1/ 35-39 BURKE ROAD

ALEXANDRIA NSW 2015 Ph. 04 5066 1226 PROJECT


17 ANEMBO AVE, GEORGES HALL, NSW 2198


ELEVATIONS

SCALE

DRAWING NO. REVISION 1:100 @ A1 DA- 502 JOB NUMBER DRAWN BY

2101 JUL 22 CC

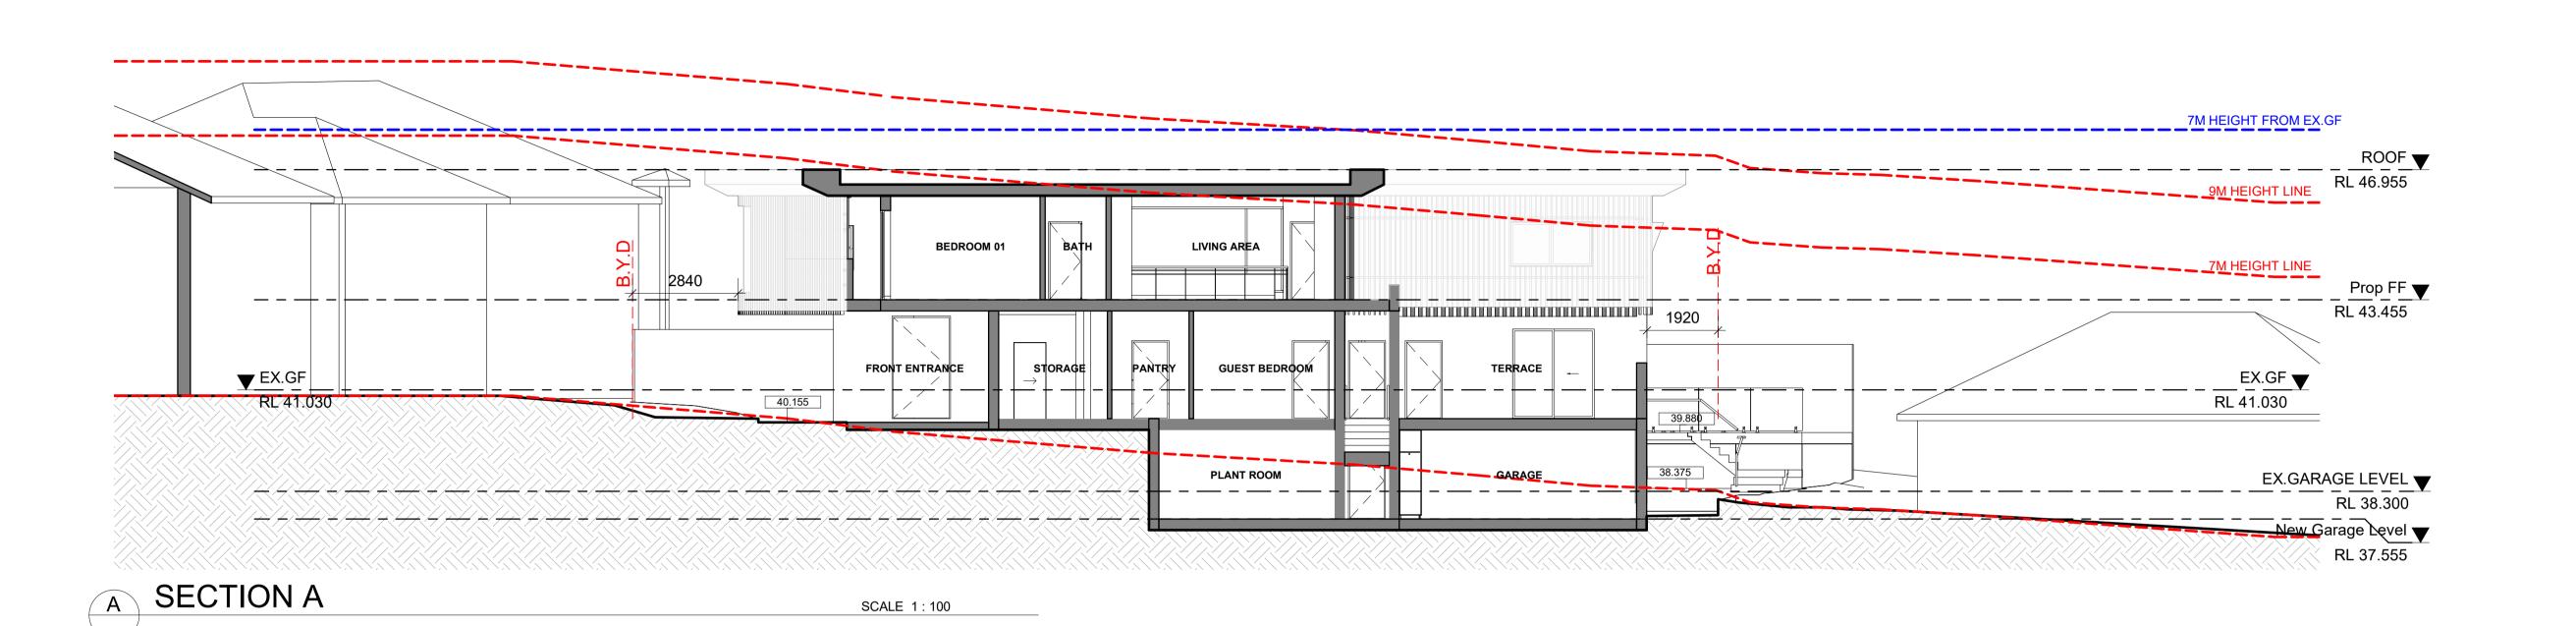

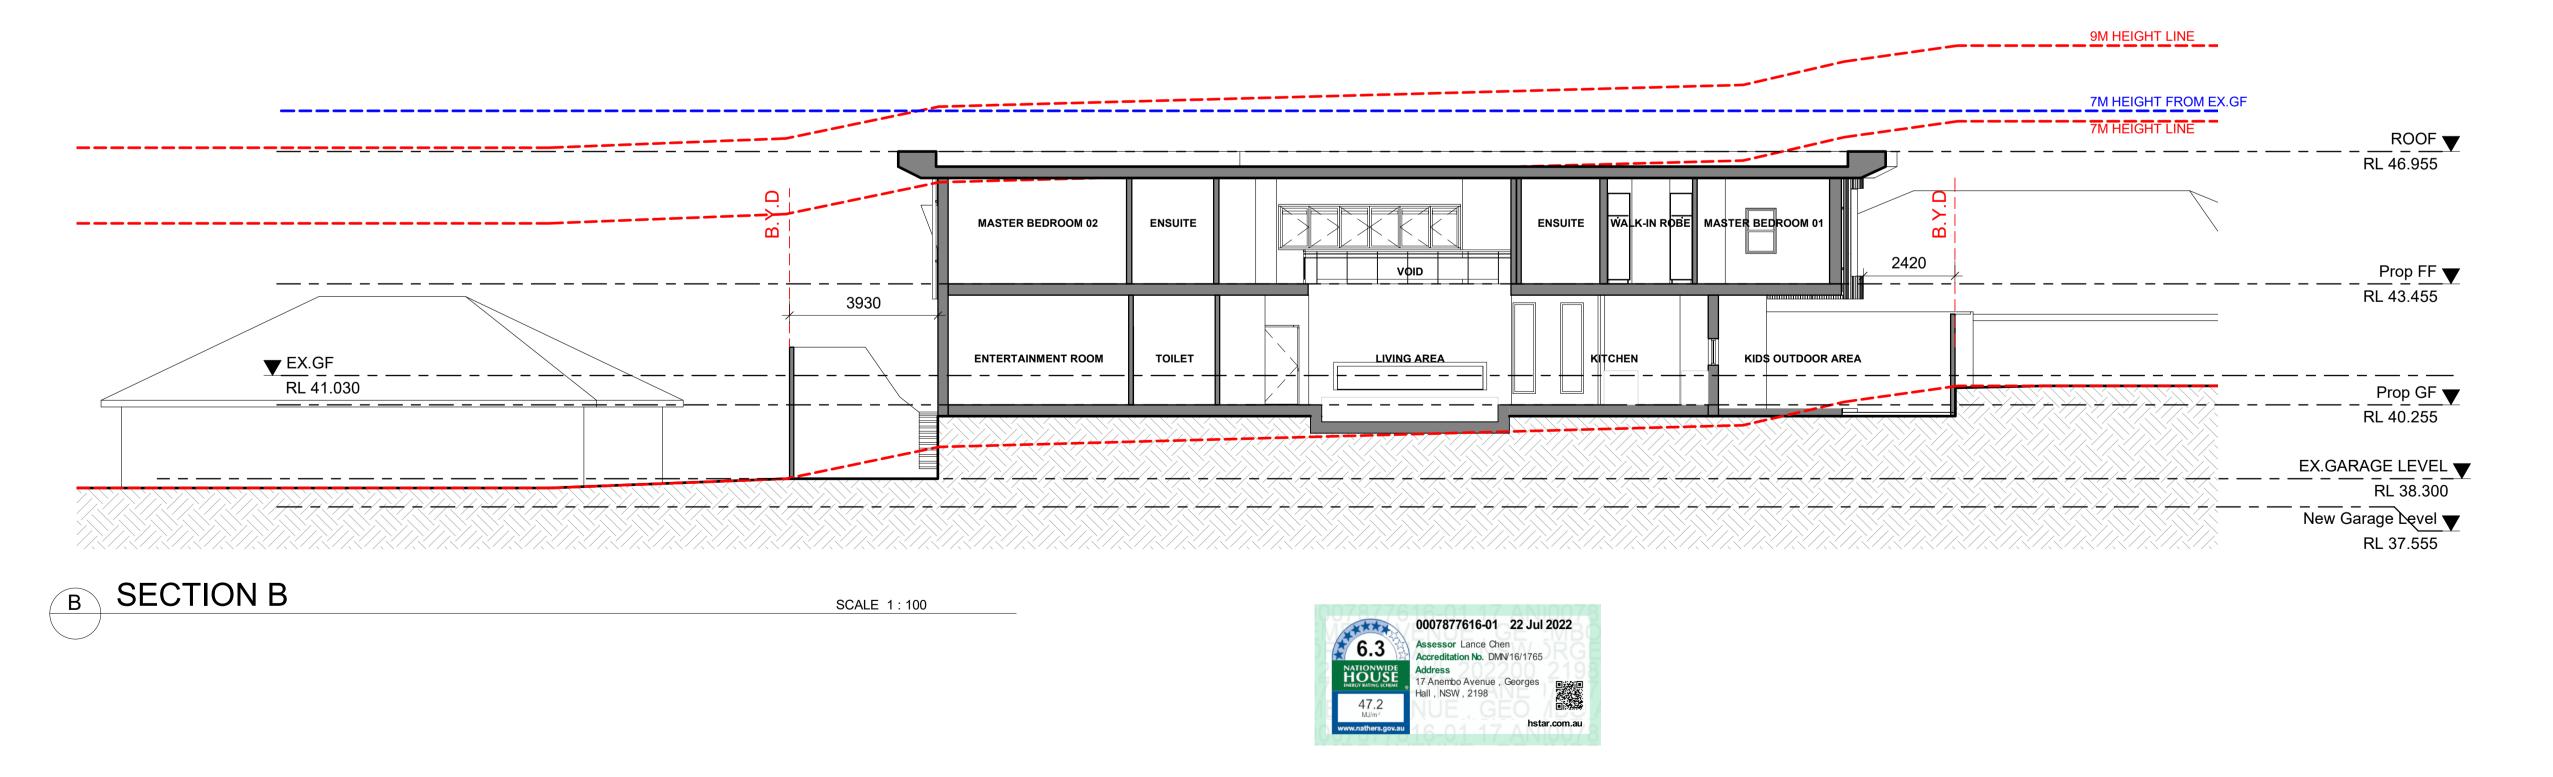

ALL LEVELS ARE INDICATIVE AND TO BE COORDINATED WITH CIVIL ENGINEER'S FUTURE DETAILS AND EARTHWORKS. ALL LEVEL ARE TO BE +/- 500 mm.

FOR DA SUBMISSION

PROJECT ADDRESS 17 ANEMBO AVE, GEORGES HALL, NSW 2198

GENERAL NOTES:


- DO NOT SCALE OFF DRAWINGS.
 USE ONLY FIGURED DIMENSIONS.
- 2. ALL DIMENSIONS ARE TO BE VERIFIED ON SITE PRIOR TO COMMENCEMENT OF ANY WORK.
- 3. ANY DISCREPANCIES ARE TO BE BROUGHT TO THE ATTENTION OF OIC DESIGN PTY LTD BEFORE COMMENCEMENT OF ANY WORK.
- . ALL DIMENSIONS ARE GIVEN IN MILLIMETRES EXCEPT LEVELS & DRAWINGS TO SCALE 1:500 AND SMALLER WHICH ARE IN METRES.
- 5. THIS DRAWING IS TO BE READ IN CONJUNCTION WITH RELEVANT CONSULTANTS DOCUMENTATION.
- 6. ALL DESIGNS, PRINTS & SPECIFICATIONS ARE THE
- PROPERTY OF OIC DESIGN PTY LTD &
 MUST NOT BE ISSUED, USED OR REPRODUCED WITHOUT WRITTEN PREMISSION FROM OIC DESIGN PTY LTD.

DA NOTES:

- . DRAWINGS ARE TO BE READ IN CONJUNCTION WITH THE DEVELOPMENT APPLICATION FORM AND STATEMENT OF ENVIRONMENTAL EFFECTS.
- 2. THE NEW BUILDING WORK IS TO BE CARRIED OUT IN ACCORDANCE WITH THE PROVISIONS OF THE BCA.
- 3. ALL NEW BUILDING WORK IS TO BE CARRIED OUT IN ACCORDANCE WITH THE NOTICE OF DETERMINATION FOR THIS DEVELOPMENT APPLICATION.
- . DISABILITY ACCESS AND FACILITIES TO BE IN ACCORDANCE WITH AS 1428.1 AND AS 1428.4
- . THE PROPOSED WORKS WILL ADDRESS FIRE SAFETY MEASURES TO COMPLY WITH THE PERFORMANCE REQUIREMENTS OF THE BCA (EITHER DEEMED TO SATISFY OR ALTERNATIVE SOLUTIONS TO BE

PREPARED BY A QUALIFIED FIRE ENGINEER).

3. ALL MEANS OF EGRESS, EMERGENCY LIGHTING, EXIT SIGNS, FIRE DOORS, FIRE HYDRANT SYSTEMS, FIRE HOSE REEL SYSTEMS, PORTABLE FIRE EXTINGUISHERS, SMOKE AND HEAT VENTS, SMOKE DETECTION, ALARM AND EXHAUST SYSTEM TO BE IN ACCORDANCE WITH THE BCA AND OTHER RELEVANT AUSTRALIAN STANDARDS.

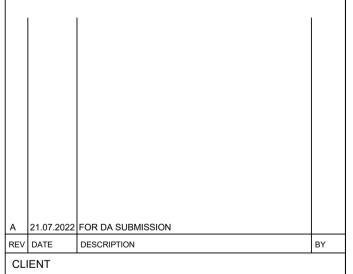

CHERYL NGUYEN

BUILDING DESIGNER

OIC

OIC DESIGN PTY LTD. (ABN 89 645 958 247) A1/ 35-39 BURKE ROAD ALEXANDRIA NSW 2015 Ph. 04 5066 1226


PROJECT

17 ANEMBO AVE, GEORGES HALL, NSW 2198


SECTIONS


SCALE DRAWING NO. REVISION DA- 601 1:100 @ A1


JOB NUMBER DRAWN BY 2101 CC JUL 22

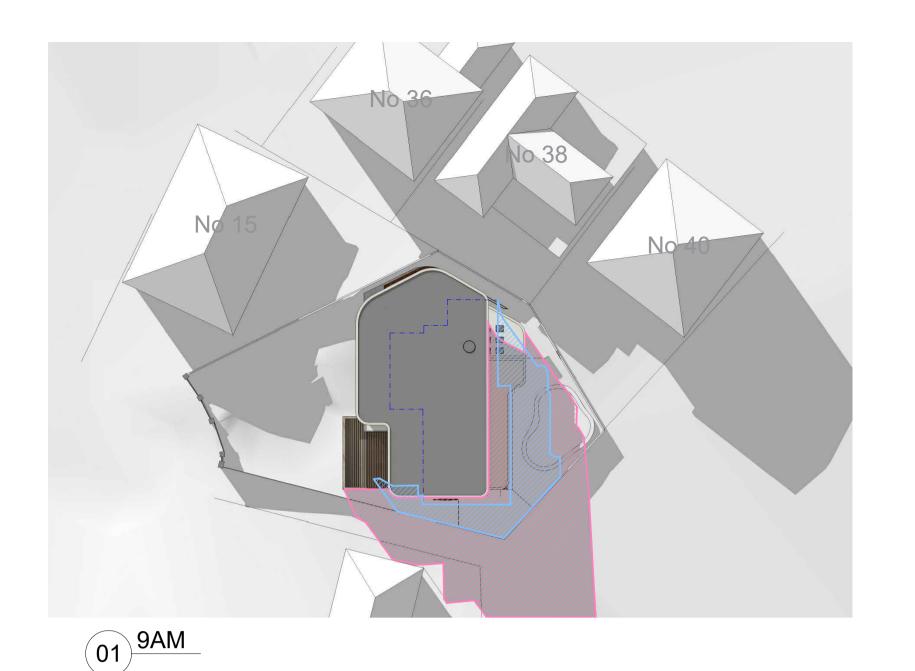





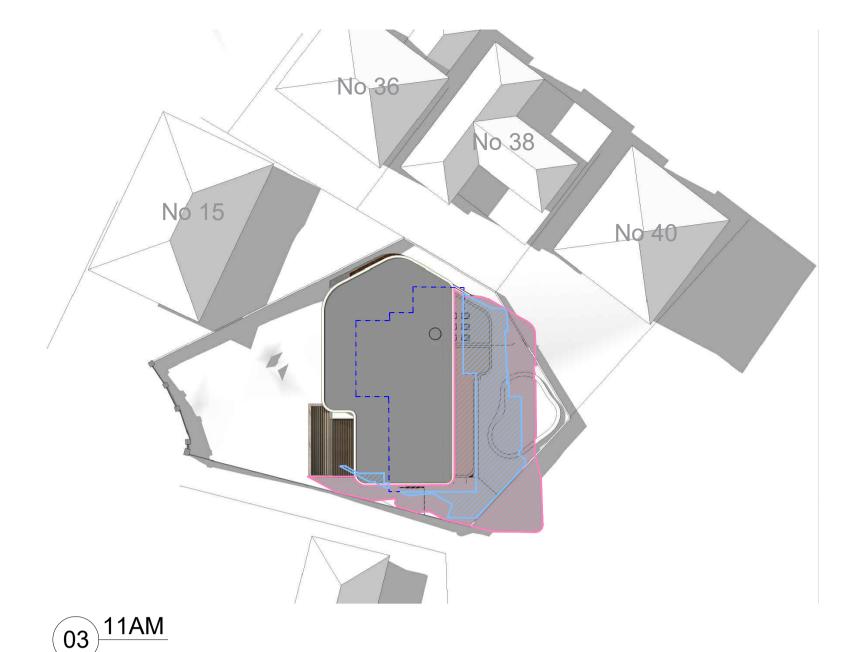

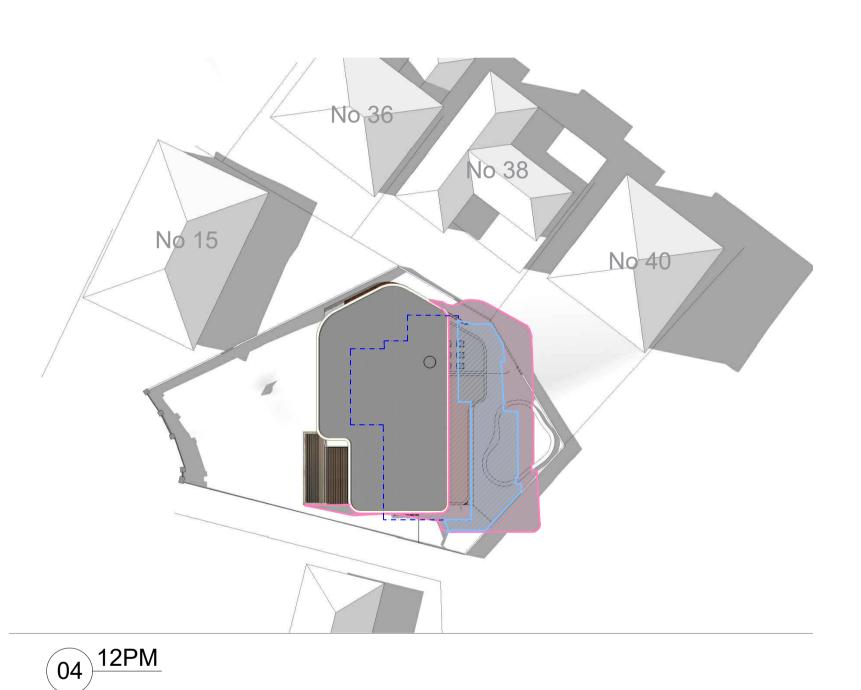

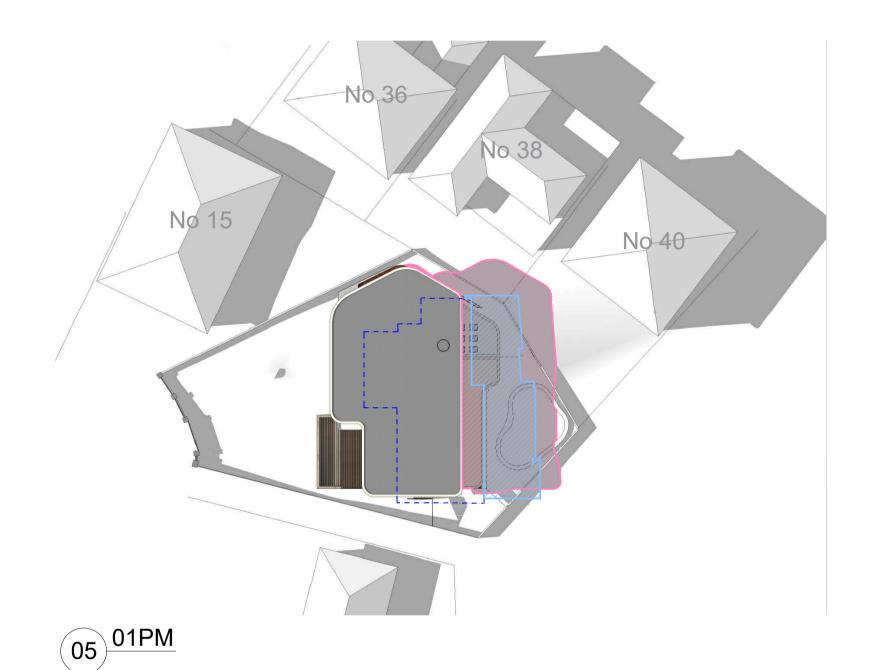

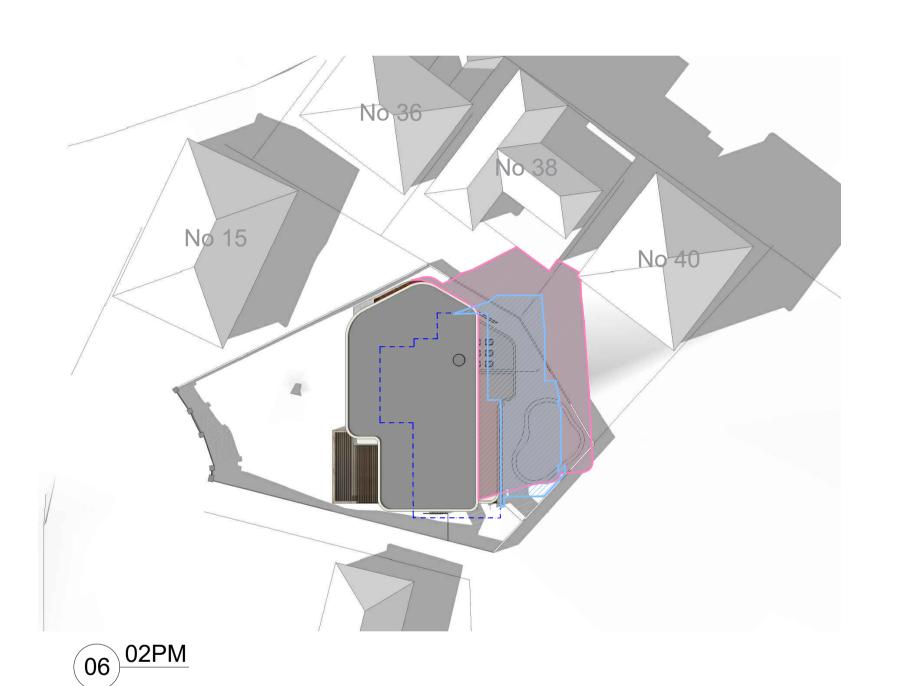

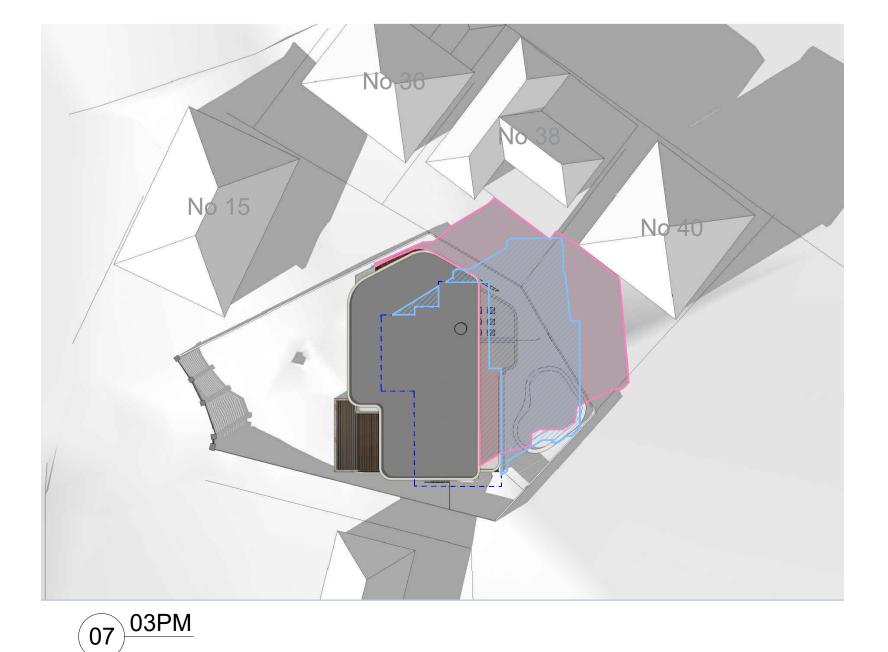

0007877616-01 22 Jul 2022 17 Anembo Avenue , Georges Hall , NSW , 2198

LEGEND

EXISTING SHADOW




PROPOSED SHADOW

EXISTING BUILDING OUTLINE

FOR DA SUBMISSION

PROJECT ADDRESS 17 ANEMBO AVE **GEORGES HALLS** NSW

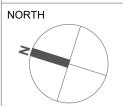

GENERAL NOTES:

DO NOT SCALE OFF DRAWINGS.
 USE ONLY FIGURED DIMENSIONS.

2. ALL DIMENSIONS ARE TO BE VERIFIED ON SITE PRIOR TO COMMENCEMENT OF ANY WORK.

3. ANY DISCREPANCIES ARE TO BE BROUGHT TO THE ATTENTION OF OIC DESIGN PTY LTD BEFORE COMMENCEMENT OF ANY WORK.

4. ALL DIMENSIONS ARE GIVEN IN MILLIMETRES EXCEPT LEVELS & DRAWINGS TO SCALE 1:500 AND SMALLER WHICH ARE IN METRES. 5. THIS DRAWING IS TO BE READ IN CONJUNCTION WITH RELEVANT CONSULTANTS DOCUMENTATION.

6. ALL DESIGNS, PRINTS & SPECIFICATIONS ARE THE PROPERTY OF OIC DESIGN PTY LTD & MUST NOT BE ISSUED, USED OR REPRODUCED WITHOUT WRITTEN PREMISSION FROM

OIC DESIGN PTY LTD.

DRAWINGS ARE TO BE READ IN CONJUNCTION WITH THE DEVELOPMENT APPLICATION FORM AND STATEMENT OF ENVIRONMENTAL EFFECTS.

2. THE NEW BUILDING WORK IS TO BE CARRIED OUT IN ACCORDANCE WITH THE PROVISIONS OF THE BCA.

3. ALL NEW BUILDING WORK IS TO BE CARRIED OUT IN ACCORDANCE WITH THE NOTICE OF DETERMINATION FOR THIS DEVELOPMENT APPLICATION.

4. DISABILITY ACCESS AND FACILITIES TO BE IN ACCORDANCE WITH AS 1428.1 AND AS 1428.4 5. THE PROPOSED WORKS WILL ADDRESS FIRE SAFETY MEASURES TO COMPLY WITH THE PERFORMANCE REQUIREMENTS OF THE BCA (EITHER DEEMED TO SATISFY OR ALTERNATIVE SOLUTIONS TO BE PREPARED BY A QUALIFIED FIRE ENGINEER).

6. ALL MEANS OF EGRESS, EMERGENCY LIGHTING, EXIT SIGNS, FIRE DOORS, FIRE HYDRANT SYSTEMS, FIRE HOSE REEL SYSTEMS, PORTABLE FIRE EXTINGUISHERS, SMOKE AND HEAT VENTS, SMOKE DETECTION, ALARM AND EXHAUST SYSTEM TO BE IN ACCORDANCE WITH THE BCA AND OTHER RELEVANT AUSTRALIAN STANDARDS.

DESCRIPTION

CHERYL NGUYEN

A 21.07.2022 FOR DA SUBMISSION

ARCHITECT OIC

REV DATE


OIC DESIGN PTY LTD. (ABN 89 645 958 247) A1/ 35-39 BURKE ROAD ALEXANDRIA NSW 2015 Ph. 04 5066 1226

PROJECT

17 ANEMBO AVE RESIDENCE

SHADOW DIAGRAM

SCALE DRAWING NO. REVISION **DA700** NTS @A1 JOB NUMBER DRAWN BY 2101 CC

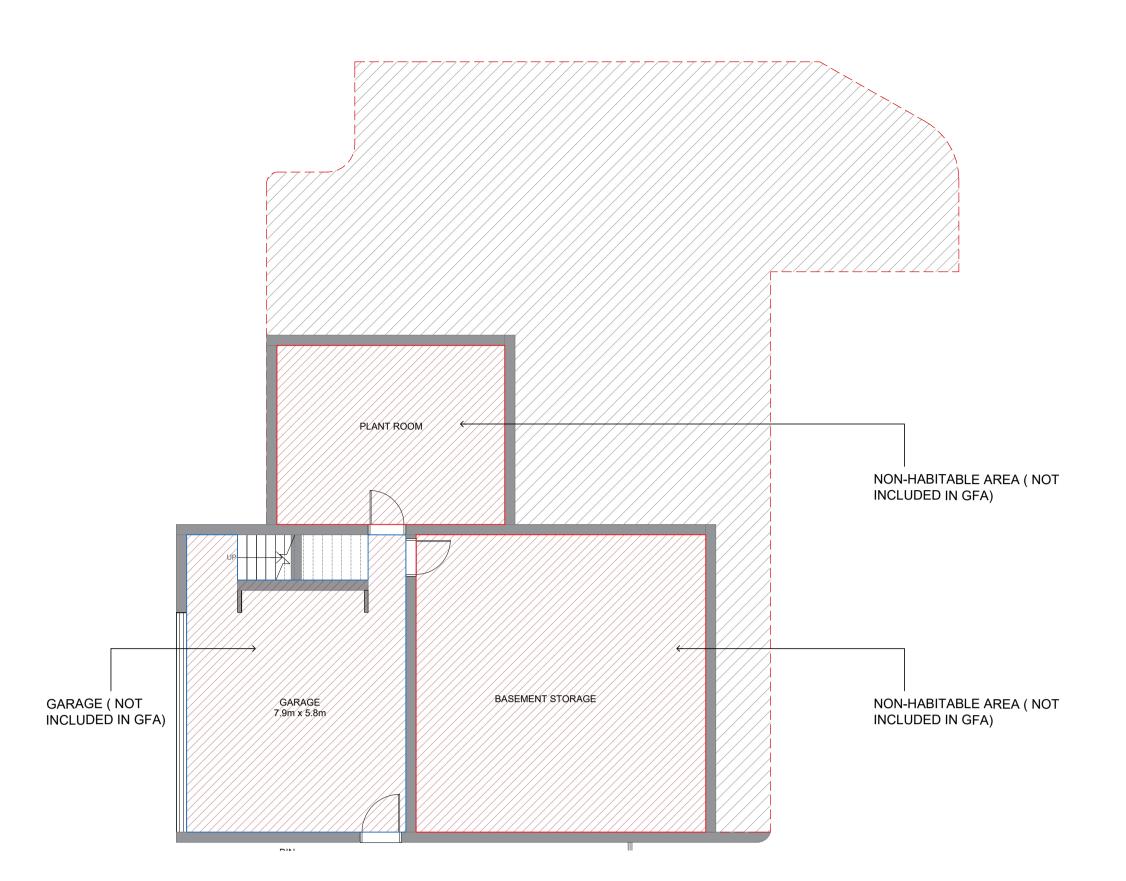


PROPOSED GARAGE GFA


41.5 SQM

02 GROUND FLOOR SCALE: 1:100 PROPOSED GROUND FLOOR GFA 246.19 SQM

GARAGE SCALE: 1:100

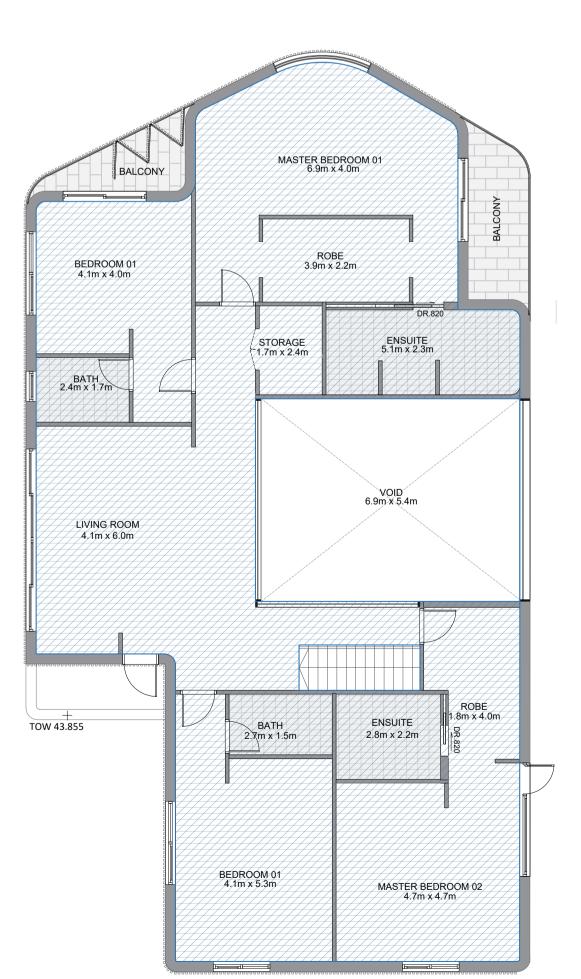

PROPOSED FIRST FLOOR GFA 202.4 SQM

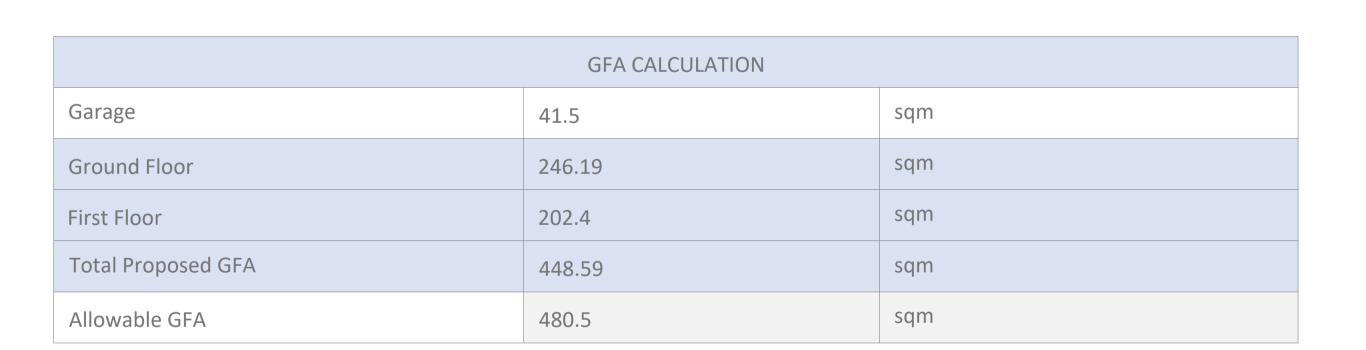

KITCHEN 2.8m x 10.1m

LIVING ROOM 4.7m x 4.3m

> MAN CAVE 4.8m x 4.8m

TOILET 2m x 2.1m

GYM 4.1m x 6.0m 14.3m x 3.0m DECK

STORAGE

PANTRY 2.1m x 3.6m

GUEST BEDROOM

3.6m x 3.8m

TERRACE 7.9m x 5.8m



PROJECT ADDRESS

17 ANEMBO AVE
GEORGES HALLS
NSW

NORTH



GENERAL NOTES:

1. DO NOT SCALE OFF DRAWINGS.

USE ONLY FIGURED DIMENSIONS.

2. ALL DIMENSIONS ARE TO BE VERIFIED ON SITE PRIOR TO COMMENCEMENT OF ANY WORK.

- 3. ANY DISCREPANCIES ARE TO BE BROUGHT TO THE ATTENTION OF OIC DESIGN PTY LTD
- BEFORE COMMENCEMENT OF ANY WORK.

 4. ALL DIMENSIONS ARE GIVEN IN MILLIMETRES EXCEPT LEVELS & DRAWINGS TO SCALE 1:500 AND
- SMALLER WHICH ARE IN METRES.

 5. THIS DRAWING IS TO BE READ IN CONJUNCTION
- WITH RELEVANT CONSULTANTS DOCUMENTATION.
- 6. ALL DESIGNS, PRINTS & SPECIFICATIONS ARE THE PROPERTY OF OIC DESIGN PTY LTD & MUST NOT BE ISSUED, USED OR REPRODUCED
- WITHOUT WRITTEN PREMISSION FROM OIC DESIGN PTY LTD.

DA NOTES:

- DRAWINGS ARE TO BE READ IN CONJUNCTION WITH THE DEVELOPMENT APPLICATION FORM AND STATEMENT OF ENVIRONMENTAL EFFECTS.
- 2. THE NEW BUILDING WORK IS TO BE CARRIED OUT IN ACCORDANCE WITH THE PROVISIONS OF THE BCA.
- 3. ALL NEW BUILDING WORK IS TO BE CARRIED OUT IN ACCORDANCE WITH THE NOTICE OF DETERMINATION
- FOR THIS DEVELOPMENT APPLICATION.

 4. DISABILITY ACCESS AND FACILITIES TO BE IN
- ACCORDANCE WITH AS 1428.1 AND AS 1428.4

 5. THE PROPOSED WORKS WILL ADDRESS FIRE SAFETY
 MEASURES TO COMPLY WITH THE PERFORMANCE
- MEASURES TO COMPLY WITH THE PERFORMANCE REQUIREMENTS OF THE BCA (EITHER DEEMED TO SATISFY OR ALTERNATIVE SOLUTIONS TO BE PREPARED BY A QUALIFIED FIRE ENGINEER).
- 6. ALL MEANS OF EGRESS, EMERGENCY LIGHTING, EXIT SIGNS, FIRE DOORS, FIRE HYDRANT SYSTEMS, FIRE HOSE REEL SYSTEMS, PORTABLE FIRE EXTINGUISHERS, SMOKE AND HEAT VENTS, SMOKE DETECTION, ALARM AND EXHAUST SYSTEM TO BE IN ACCORDANCE WITH THE BCA AND OTHER RELEVANT AUSTRALIAN STANDARDS.

A 21.07.2022 FOR DA SUBMISSION

REV DATE DESCRIPTION

CLIENT

CHERYL NGUYEN

ARCHITECT C

OIC DESIGN PTY LTD. (ABN 89 645 958 247) A1/ 35-39 BURKE ROAD ALEXANDRIA NSW 2015 Ph. 04 5066 1226

PROJECT

17 ANEMBO AVE RESIDENCE

GFA CALCULATION DIAGRAM

SCALE 1:100 @A1	DA800	REVISION
JOB NUMBER	DRAWN BY	DATE
2101	CC	JUL 22

GLAZING SCHEDULE

			DE	ETAIL	
MARK	TYPE	SILL HEIGHT	HEIGHT	WIDTH	REMARK
GROUND FLOOR					
G.01	А	300	2400	600	FIXED
G.02	А	300	2400	600	FIXED
G.03	В	900	1200	800	SINGLE-HUNG WINDOW
G.04	С	900	1200	2200	2 PANEL SLIDING WINDOW
G.05	D		2600	2200	2 PANEL SLIDING DOOR
G.06	D		2600	2200	2 PANEL SLIDING DOOR
G.07	E		2800	6200	4 PANEL SLIDING DOOR
G.08	F		2600	3010	3 PANEL FOLDING
G.09	G	1050	700	1200	FIXED
G.10	Н	1050	700	5390	FIXED
G.11	I		2600	1500	SWING GLAZING DOOR AND FIXED PANEL
IRST FLOOR					
F.01	D		2400	2200	2 PANEL SLIDING DOOR
F.02	С	900	1200	2200	2 PANEL SLIDING WINDOW
F.03	В	900	1200	800	SINGLE-HUNG WINDOW
F.04	J	900	1200	4820	6 PANEL FOLDING
F.05	С	900	1200	2200	2 PANEL SLIDING WINDOW
F.06	K	900	1200	1500	2 PANEL SLIDING WINDOW
F.07	K	900	1200	1500	2 PANEL SLIDING WINDOW
F.08	С	200	2300	3000	SWING GLAZING DOOR AND FIXED PANEL
F.09	L	200	2300	5370	FIXED
F.10	D		2500	2200	2 PANEL SLIDING DOOR
F.11	M	200	2300	2510	CUSTOMISED FIXED CURVED WINDOW
F.12	Р	400	2100	950	SINGLE GLAZING SWING DOOR
SKYLIGHT					
		DIAMETER	LENGTH	WIDTH	
SK.01	N		780	650	FIXED
SK.02	N		780	650	FIXED
SK.03	N		780	650	FIXED
SK.04	N		780	650	FIXED
SK.05	О	1370			FIXED



PROJECT ADDRESS 17 ANEMBO AVE GEORGES HALLS NSW

NORTH

GENERAL NOTES:

- DO NOT SCALE OFF DRAWINGS.
 USE ONLY FIGURED DIMENSIONS.
- 2. ALL DIMENSIONS ARE TO BE VERIFIED ON SITE PRIOR TO COMMENCEMENT OF ANY WORK.
- 3. ANY DISCREPANCIES ARE TO BE BROUGHT TO THE ATTENTION OF OIC DESIGN PTY LTD BEFORE COMMENCEMENT OF ANY WORK.
- 4. ALL DIMENSIONS ARE GIVEN IN MILLIMETRES EXCEPT LEVELS & DRAWINGS TO SCALE 1:500 AND SMALLER WHICH ARE IN METRES.
- 5. THIS DRAWING IS TO BE READ IN CONJUNCTION WITH RELEVANT CONSULTANTS DOCUMENTATION. 6. ALL DESIGNS, PRINTS & SPECIFICATIONS ARE THE
- PROPERTY OF OIC DESIGN PTY LTD &

 MUST NOT BE ISSUED, USED OR REPRODUCED WITHOUT WRITTEN PREMISSION FROM OIC DESIGN PTY LTD.

DA NOTES:

- 1. DRAWINGS ARE TO BE READ IN CONJUNCTION WITH THE DEVELOPMENT APPLICATION FORM AND STATEMENT OF ENVIRONMENTAL EFFECTS.
- 2. THE NEW BUILDING WORK IS TO BE CARRIED OUT IN
- ACCORDANCE WITH THE PROVISIONS OF THE BCA. 3. ALL NEW BUILDING WORK IS TO BE CARRIED OUT IN ACCORDANCE WITH THE NOTICE OF DETERMINATION
- FOR THIS DEVELOPMENT APPLICATION.
- 4. DISABILITY ACCESS AND FACILITIES TO BE IN ACCORDANCE WITH AS 1428.1 AND AS 1428.4

PREPARED BY A QUALIFIED FIRE ENGINEER).

- 5. THE PROPOSED WORKS WILL ADDRESS FIRE SAFETY MEASURES TO COMPLY WITH THE PERFORMANCE REQUIREMENTS OF THE BCA (EITHER DEEMED TO SATISFY OR ALTERNATIVE SOLUTIONS TO BE
- 6. ALL MEANS OF EGRESS, EMERGENCY LIGHTING, EXIT SIGNS, FIRE DOORS, FIRE HYDRANT SYSTEMS, FIRE HOSE REEL SYSTEMS, PORTABLE FIRE EXTINGUISHERS, SMOKE AND HEAT VENTS, SMOKE DETECTION, ALARM AND EXHAUST SYSTEM TO BE IN ACCORDANCE WITH THE BCA AND OTHER RELEVANT AUSTRALIAN STANDARDS.

A 21.07.2022 FOR DA SUBMISSION REV DATE DESCRIPTION

CHERYL NGUYEN

ARCHITECT

OIC DESIGN PTY LTD. (ABN 89 645 958 247) A1/ 35-39 BURKE ROAD ALEXANDRIA NSW 2015 Ph. 04 5066 1226

PROJECT

CLIENT

17 ANEMBO AVE RESIDENCE

GLAZING SCHEDULE

CALE	DRAWING NO.	REVISION
NTS @A1	DA900	Α
OB NUMBER	DRAWN BY	DATE
2101	CC	JUL 22

FOR DA SUBMISSION